

## **MEMORANDUM**

To: All Interested Vendors

From: Theresa Kauffman-Bidwell

IT Vendor and Procurement

Administrator

Date: March 11, 2022

Subject: Addendum No. 2

RFP 22-015 Security Equipment Sourcing, Configuration, & Installation

Services

**Gahanna Technology Site Plans** 

## Part I.

RFP 22-015 Security Equipment Sourcing, Configuration, & Installation Services site plans have been added.

Bids are due by 12:00 PM, noon, on Tuesday, March 30, 2022 to <a href="mailto:procurement@columbuslibrary.org">procurement@columbuslibrary.org</a>.

ANSI	ECHNOLOGY SYSTEMS ABBREVIATIONS  AMERICAN NATIONAL STANDARDS INSTITUTE
ANSI AP	ACCESS POWER
ATM	AUTOMATIC TELLER MACHINE
AWG BAS	AMERICAN WIRE GAUGE BUILDING AUTOMATION SYSTEM
ВСТ	BONDING CONDUCTOR FOR TELECOMMUNICATIONS
BICSI	BUILDING INDUSTRY CONSULTING SERVICE INTERNATIONAL
BMS CAD	BUILDING MANAGEMENT SYSTEM COMPUTER-AIDED DESIGN
CAN	CAMPUS AREA NETWORK
CATV	COMMUNITY ANTENNA TELEVISION (CABLE TELEVISION)
CCTV CM	CLOSED-CIRCUIT TELEVISION COMMUNICATIONS GENERAL-PURPOSE CABLE (CABLE MARKING
CMP	PER NFPA 70) COMMUNICATIONS PLENUM CABLE (CABLE MARKING AS
CMR	NFPA 70)  COMMUNICATIONS RISER CABLE (CABLE MARKING AS NFPA 70)
COAX	COAXIAL CABLE
CPC CPE	CUSTOMER PREMISES COMMUNICATIONS CUSTOMER PREMISES EQUIPMENT
CPU	CENTRAL PROCESSING UNIT
CSI CT	CONSTRUCTION SPECIFICATIONS INSTITUTE CABLE TRY
DAS	DISTRIBUTED ANTENNA SYSTEM
dB dBmV	DECIBEL DECIBEL MILLIVOLT
ΞF	ENTERANCE FACILITY
EIA ED	ELECTRONIC INDUSTRIES ALLIANCE
ER FCC	EQUIPMENT ROOM FEDERAL COMMUNICATIONS COMMISSION
FDDI	FIBER DISTRIBUTED DATA INTERFACE
Gb GC	GIGABIT GENERAL CONTRACTOR
HC	HORIZONTAL CROSS-CONNECT
HH HVAC	HANDHOLE HEATING, VENTILATING, AND AIR CONDITIONING
C	INTERMEDIATE CROSS-CONNECT
IDC	INSIDE DIAMETER
IDC IEEE	INSULATION DISPLACEMENT CONNECTOR INSTITUE OF ELECTRICAL AND ELECTRONICS ENGINEERS, INC.
IG	ISOLATED GROUND
I/O IP	INPUT/OUTPUT (DEVICE) INTERNET PROTOCOL
r T	INFORMATION TECHNOLOGY
<b>KVM</b>	KEYBOARD/VIDEO/MOUSE
_AN MATV	LOCAL AREA NETWORK MASTER ANTENNA TELEVISION
Mb	MEGABIT
Mb/s	MEGABIT PER SECOND
MC MD	MAIN CROSS-CONNECT MAIN DISTRIBUTER
MDF	MAIN DITRIBUTION FRAME
MH MM	MAINTENANCE HOLE MULTIMODE
MPOP	MINIMUM POINT OF PRESENCE
MSDS	MATERIAL SAFETY DATA SHEET
MUTOA NA	MULTI-USER TELECOMMUNICATIONS OUTLET ASSEMBLY NON-APPLICABLE
NEC	NATIONAL ELECTRICAL CODE
NIC DD	NETWORK INTERFACE CARD OUTSIDE DIAMETER
OEM	ORIGINAL EQUIPMENT MANUFACTURER
OFCR	OPTICAL FIBER CONDUCTIVE RISER CABLE
OFNP OFNR	OPTICAL FIBER NONCONDUCTIVE PLENUM CABLE OPTICAL FIBER NONCONDUCTIVE RISER CABLE
OSP	OUTSIDE PLANT
OTDR PA	OPTICAL TIME DOMAIN REFLECTOMETER PUBLIC ADDRESS
PABX	PRIVATE AUTOMATIC BRANCH EXCHANGE
PBX	PRIVATE BRANCH EXCHANGE
PM PoE	PROJECT MANAGER POWER OVER ETHERNET
or	PAIR
PSTN PTZ	PUBLIC SWITCHED TELEPHONE NETWORK
PVC	PAN,TILT, AND ZOOM POLYVINYL CHLORIDE
QoS	QUALITY OF SERVICE
RCDD RF	REGISTERED COMMUNICATIONS DISTRIBUTION DESIGNER RADIO FREQUENCY
RFI	REQUEST FOR INFORMATION
RFID	RADIO FREQUENCY INDENTIFICATION
RGB RU	RED, GREEN, BLUE RACK UNIT
SAN	STORAGE ARE NETWORK
SCS ScTD	STRUCTURED CABLING SYSTEM SCREENED TWISTED-PAIR
ScTP SFF	SCREENED TWISTED-PAIR SMALL FORM FACTOR
SM	SINGLEMODE
STP SVGA	SHIELDED TWISTED-PAIR SUPER VIDEO GRAPHICS ARRAY
ТВВ	TELECOMMUNICATIONS BONDING BACKBONE
ГС	TELECOMMUNICATIONS CLOSET (SEE TELECOMMUNICATIONS
TDD	ROOM) TELECOMMUNICATIONS DEVICE FOR THE DEAF
ГОММ	TELECOMMUNICATIONS DISTRIBUTION METHODS MANUAL
ГGB ГIA	TELECOMMUNICATIONS GROUNDING BUSBAR TELECOMMUNICATIONS INDUSTRY ASSOCIATION
TIA TMGB	TELECOMMUNICATIONS INDUSTRY ASSOCIATION TELECOMMUNICATIONS MAIN GROUNDING BUSBAR
TR	TELECOMMUNICATIONS ROOM
TTY TV	TELETYPEWRITER/TEXT TELEPHONE TELEVISION
UBC	UNIFORM BUILDING CODE
UL UDC	UNDERWRITERS LABORATORIES INC.
JPS JSOC	UNINTERRUPTIBLE POWER SUPPLY UNIVERSAL SERVICE ORDER CODE
JTP	UNSHIELDED TWISTED-PAIR
VoIP WAN	VOICE OVER INTERNET PROTOCOL
*** ****	WIDE AREA NETWORK
WAP	WIRELESS ACCESS POINT

	TECHNOLOGY GENERAL NOTES
1.	DO NOT SCALE DRAWINGS. VERIFY DIMENSIONS IN FIELD PRIOR TO COMMENCEMENT OF WORK.
2.	WHEREVER THE WORD PROVIDE IS USED IT SHALL MEAN TO "FURNISH AND INSTALL".
3.	IT IS THE INTENT OF THESE DRAWINGS AND SPECIFICATIONS TO ESTABLISH A STANDARD OF QUALITY. THE OWNER RESERVES THE RIGHT TO APPROVE METHODS AND MATERIALS NOT REFLECTED HERE IN.
4.	CONTRACTOR SHALL VISIT SITE PRIOR TO BID AND VERIFY THAT CONDITIONS ARE AS INDICATED. CONTRACTOR SHALL INCLUDE IN THIS BID COSTS REQUIRED TO MAKE HIS WORK MEET EXISTING CONDITIONS.
5.	WORK SHALL BE PERFORMED IN A WORKMANLIKE MANNER TO THE SATISFACTION OF THE OWNER.
6.	WORK, MATERIALS, AND EQUIPMENT SHALL CONFORM TO THE LATEST EDITIONS OF LOCAL, STATE, AND NATIONAL CODES, ORDINANCES AND STANDARDS.
7.	PROVIDE AS-BUILT DRAWINGS. INCLUDE ALL ADDENDUM ITEMS, CHANGE ORDERS, ALTERATIONS, REROUTINGS, ETC.
8.	VERIFY EXACT LOCATION OF EQUIPMENT PRIOR TO ROUGH-IN.
9.	ALL CABLING THAT PASSES THROUGH OR ORIGINATES IN EXPOSED CEILING SPACES SHALL BE INSTALLED IN LISTED METALLIC RACEWAYS. RACEWAYS IN SLAB-ON-GRADE OR BELOW GRADE SHALL BE SCHEDULE 40 P.V.C. TRANSITIONS FROM BELOW TO ABOVE GRADE SHALL BE WITH RIGID STEEL ELBOWS. EMT FITTINGS SHALL BE MALLEABLE IRON OR STEEL CONNECTORS SHALL BE INSULATED THROAT TYPE.
10.	CONDUITS LARGER THAN 1" SHALL HAVE LONG RADIUS SWEEPS (12 TIMES THE DIAMETER).
11.	THERE SHALL BE NO MORE THAN TWO 90 DEGREE BENDS BETWEEN PULL BOXES. PULL BOXES AND CABLE TRAYS SHOWN ON DRAWINGS SHALL BE CONSIDERED THE MINIMUM REQUIREMENTS. CONTRACTOR SHALL INSTALL PULL BOXES ACCORDING TO FIELD CONDITIONS.
12.	ALL CABLING ABOVE ACCESSIBLE CEILING AREAS, WHERE NOT IN CABLE TRAY, SHALL BE SUPPORTED WITH A J-HOOK SUPPORT SYSTEM EVERY 4' ON CENTER. J-HOOK SHALL NOT BE SUPPORTED BY OR OTHERWISE ATTACHED TO THE SUSPENDED CEILING GRID WIRES OR ANY OTHER BUILDING ANCILLARY SYSTEM SUCH AS ELECTRICAL OR PLUMBING CONDUITS.
13.	REFER TO ARCHITECTURAL PLANS FOR WALL CONSTRUCTION.
14.	ALL CONDUITS IN AREAS WITHOUT SUSPENDED CEILINGS SHALL BE RUN AS INCONSPICUOUSLY AS POSSIBLE, HIDDEN BEHIND BEAMS, CLOSE TO DECK, ETC. OBTAIN APPROVAL OF CONDUIT RUNS BELOW BEAMS WITH OWNER'S REPRESENTATIVE.
15.	RACEWAYS SHALL BE RUN AS INCONSPICUOUSLY AS POSSIBLE. VERTICAL RUNS SHALL OCCUR IN CORNERS OF ROOMS. HORIZONTAL RUNS SHALL OCCUR ALONG BASEBOARD OF WALL WITH VERTICAL RUNS UP TO THE DEVICE BOXES BRANCHING OUT OF CORNER BOXES, TEES OR ELBOWS.
16.	ADD STEEL BRIDGING BETWEEN PURLINS/JOISTS/BEAMS AS NECESSARY TO SUPPORT THE WEIGHT OF SUSPENDED DEVICES AND FIXTURES.
17.	ALL DEVICES IN CEILINGS IN A ROOM SHALL BE ALIGNED.
18.	AT EXISTING LOCATION WHERE WALL FURRING DEPTH IS TOO SHALLOW FOR A STANDARD DEPTH JUNCTION BOX, CONTRACTOR SHALL CHISEL OU SURROUNDING MATERIAL SO THAT BOX IS FLUSH WITH WALL. WHERE CONDUIT IS TOO DEEP, CONTRACTOR SHALL CHANNEL OUT SURROUNDING MATERIAL. EXPOSED SURFACE MOUNTED CONDUIT AND JUNCTION BOXES ARE PROHIBITED.
19.	REFER TO ALL SITE PLANS FOR SITE REQUIREMENTS.
20.	PROVIDE SURFACE RACEWAY SIZE ADEQUATE FOR QUANTITY OF DATA CABLES.
21.	COORDINATE WITH OWNER FOR EXACT MOUNTING HEIGHT AND LOCATION OF ALL WALL-MOUNTED SECURITY CAMERAS.

TECHNOLOGY SHEET INDEX						
SHEET NUMBER	SHEET NAME					
T-000	TECHNOLOGY SYMBOLS AND LEGENDS					
T-001	TECHNOLOGY SITE PLAN					
T-201	LEVEL 01 TECHNOLOGY PLAN					
T-203	LEVEL 02 TECHNOLOGY PLAN					
T-401	TECHNOLOGY ENLARGED PLANS					
T-701	TECHNOLOGY DETAILS					
T-702	TECHNOLOGY DETAILS					
T-703	TECHNOLOGY DETAILS					

TECHNOLOGY DETAILS

	SOME SYMBOLS MAY NOT BE USED.	
	2. MOUNTING HEIGHTS ARE TO TOP U.N.O.	MOUNTI
SYMBOL	•	HEIGHT UN OTED OTHE
	AUDIO/VISUAL SYMBOLS	
AV	ROUGH IN FOR AUDIO/VISUAL OUTLET. PROVIDE 4-11/16" DEEP BOX W/ DOUBLE GANG RING AND (2) 1-1/4" CONDUITS STUBBED TO ABOVE ACCESSIBLE CEILING FOR LAY-IN CEILING APPLICATION (CONDUITS EXTENDED TO PROJECTOR FOR EXPOSED CEILING APPLICATIONS).	20" NS
(AV)	MULTIMEDIA INPUT/OUTPUT PLATE	
QM	CRESTRON QM-WMC-MIC-OUTLET	
TS	CRESTRON TOUCHSCREEN CONTROLLER	
$[H]$ ; $\vdash$ $[H]$	HORN TYPE SPEAKER, CEILING MOUNTED; WALL MOUNTED	94"
SP	SOUND SYSTEM SPEAKER PENDANT MOUNTED	
s	SOUND SYSTEM SPEAKER WITH INTEGRAL VOLUME CONTROL	
s ;   s	SOUND SYSTEM SPEAKER, CEILING MOUNTED; WALL MOUNTED	94"
SP *	SOUND SYSTEM SPEAKER ZONE PENDANT MOUNTED  * = ZONE NUMBER	
СР	VOLUME CONTROLLER	
s , ;   s ,	SOUND SYSTEM SPEAKER ZONE, CEILING MOUNTED; WALL MOUNT	ΓED 94"
(S)(	* = ZONE NUMBER  SOUND SYSTEM OUTDOOR HORN SPEAKER	
SPKR	GYMNASIUM SPEAKERS. MOUNT ON STRUCTURAL BEAMS AND AIM AT CENTER ROW OF SEATS.	
V	SOUND SYSTEM VOLUME ATTENUATOR	48"
P	PROJECTOR, CEILING MOUNTED.	
TV	VIDEO MONITOR OUTLET	
AV	AUDIO/VISUAL OUTLET. PROVIDE 4-11/16" DEEP BOX W/ DOUBLE GANG RING AND (2) 1-1/4" CONDUITS STUBBED TO ABOVE ACCESSIBLE CEILING FOR LAY-IN CEILING APPLICATIONS (CONDUITS EXTENDED TO PROJECTOR FOR EXPOSED CEILING APPLICATIONS). L = LOW OUTLET	SEE DRAW
ВТ	BLUETOOTH AUDIO RECEIVER	48"
Φ Φ	MICROPHONE OUTLET, WALL MOUNTED; FLOOR MOUNTED	20"
⊕ ; ⊕ <sub>F</sub>		
·	SUAL IS NOT IN CONTRACT FOR THIS BID. SYMBOLS FOR REFERENCE  SECURITY SYMBOLS	ONLY
·		ONLY
AUDIO/VIS	SECURITY SYMBOLS  PUSHBUTTON STATION INTERIOR SECURITY SYSTEM CAMERA	48" CEILING
AUDIO/VIS	SECURITY SYMBOLS PUSHBUTTON STATION	48"
AUDIO/VIS	SECURITY SYMBOLS  PUSHBUTTON STATION  INTERIOR SECURITY SYSTEM CAMERA EXTERIOR SECURITY SYSTEM CAMERA, "PTZ" = PAN, TILT, ZOOM  SECURITY SYSTEM CARD READER	48" CEILING 144"
AUDIO/VIS	SECURITY SYMBOLS  PUSHBUTTON STATION  INTERIOR SECURITY SYSTEM CAMERA EXTERIOR SECURITY SYSTEM CAMERA, "PTZ" = PAN, TILT, ZOOM  SECURITY SYSTEM CARD READER  INTERCOM; MASTER, SLAVE STATION	48" CEILING 144" 48"
AUDIO/VIS	SECURITY SYMBOLS  PUSHBUTTON STATION  INTERIOR SECURITY SYSTEM CAMERA EXTERIOR SECURITY SYSTEM CAMERA, "PTZ" = PAN, TILT, ZOOM  SECURITY SYSTEM CARD READER  INTERCOM; MASTER, SLAVE STATION  SECURITY SYSTEM KEY PAD	48" CEILING 144" 48" 48"
AUDIO/VIS	SECURITY SYMBOLS  PUSHBUTTON STATION  INTERIOR SECURITY SYSTEM CAMERA EXTERIOR SECURITY SYSTEM CAMERA, "PTZ" = PAN, TILT, ZOOM  SECURITY SYSTEM CARD READER INTERCOM; MASTER, SLAVE STATION  SECURITY SYSTEM KEY PAD  SECURITY SYSTEM MOTION DETECTOR	48" CEILING 144" 48" 48"
AUDIO/VIS	SECURITY SYMBOLS  PUSHBUTTON STATION  INTERIOR SECURITY SYSTEM CAMERA EXTERIOR SECURITY SYSTEM CAMERA, "PTZ" = PAN, TILT, ZOOM  SECURITY SYSTEM CARD READER  INTERCOM; MASTER, SLAVE STATION  SECURITY SYSTEM KEY PAD  SECURITY SYSTEM MOTION DETECTOR  SECURITY SYSTEM DOOR POSITION SWITCH	48" CEILING 144" 48" 48" CEILING
AUDIO/VIS	SECURITY SYMBOLS  PUSHBUTTON STATION  INTERIOR SECURITY SYSTEM CAMERA EXTERIOR SECURITY SYSTEM CAMERA, "PTZ" = PAN, TILT, ZOOM  SECURITY SYSTEM CARD READER INTERCOM; MASTER, SLAVE STATION  SECURITY SYSTEM KEY PAD  SECURITY SYSTEM MOTION DETECTOR	48" CEILING 144" 48" 48"
AUDIO/VIS	SECURITY SYMBOLS  PUSHBUTTON STATION INTERIOR SECURITY SYSTEM CAMERA EXTERIOR SECURITY SYSTEM CAMERA, "PTZ" = PAN, TILT, ZOOM SECURITY SYSTEM CARD READER INTERCOM; MASTER, SLAVE STATION SECURITY SYSTEM KEY PAD SECURITY SYSTEM MOTION DETECTOR SECURITY SYSTEM DOOR POSITION SWITCH SECURITY SYSTEM GLASS BREAK DETECTION PUSHBUTTON STATION	48" CEILING 144" 48" 48" CEILING
AUDIO/VIS	SECURITY SYMBOLS  PUSHBUTTON STATION  INTERIOR SECURITY SYSTEM CAMERA EXTERIOR SECURITY SYSTEM CAMERA, "PTZ" = PAN, TILT, ZOOM  SECURITY SYSTEM CARD READER  INTERCOM; MASTER, SLAVE STATION  SECURITY SYSTEM KEY PAD  SECURITY SYSTEM MOTION DETECTOR  SECURITY SYSTEM DOOR POSITION SWITCH  SECURITY SYSTEM GLASS BREAK DETECTION	48" CEILING 144" 48" 48" CEILING
AUDIO/VIS	SECURITY SYMBOLS  PUSHBUTTON STATION  INTERIOR SECURITY SYSTEM CAMERA EXTERIOR SECURITY SYSTEM CAMERA, "PTZ" = PAN, TILT, ZOOM  SECURITY SYSTEM CARD READER  INTERCOM; MASTER, SLAVE STATION  SECURITY SYSTEM KEY PAD  SECURITY SYSTEM MOTION DETECTOR  SECURITY SYSTEM DOOR POSITION SWITCH  SECURITY SYSTEM GLASS BREAK DETECTION  PUSHBUTTON STATION  VOICE/DATA SYMBOLS	48" CEILING 48" 48" CEILING CEILING
AUDIO/VIS	SECURITY SYMBOLS  PUSHBUTTON STATION INTERIOR SECURITY SYSTEM CAMERA EXTERIOR SECURITY SYSTEM CAMERA, "PTZ" = PAN, TILT, ZOOM SECURITY SYSTEM CARD READER INTERCOM; MASTER, SLAVE STATION  SECURITY SYSTEM KEY PAD SECURITY SYSTEM MOTION DETECTOR SECURITY SYSTEM DOOR POSITION SWITCH SECURITY SYSTEM GLASS BREAK DETECTION PUSHBUTTON STATION  VOICE/DATA SYMBOLS WIRELESS ACCESS POINT, (2) CAT6A UTP	48" CEILING 48" 48" CEILING CEILING
AUDIO/VIS	SECURITY SYMBOLS  PUSHBUTTON STATION INTERIOR SECURITY SYSTEM CAMERA EXTERIOR SECURITY SYSTEM CAMERA, "PTZ" = PAN, TILT, ZOOM SECURITY SYSTEM CARD READER INTERCOM; MASTER, SLAVE STATION SECURITY SYSTEM KEY PAD SECURITY SYSTEM MOTION DETECTOR SECURITY SYSTEM DOOR POSITION SWITCH SECURITY SYSTEM GLASS BREAK DETECTION PUSHBUTTON STATION  VOICE/DATA SYMBOLS WIRELESS ACCESS POINT, (2) CAT6A UTP 1 PORT, WALL MOUNT, (1) CAT6 UTP	48" CEILING 48" 48" 48" CEILING CEILING 20"
AUDIO/VIS	SECURITY SYMBOLS  PUSHBUTTON STATION INTERIOR SECURITY SYSTEM CAMERA EXTERIOR SECURITY SYSTEM CAMERA, "PTZ" = PAN, TILT, ZOOM SECURITY SYSTEM CARD READER INTERCOM; MASTER, SLAVE STATION SECURITY SYSTEM KEY PAD SECURITY SYSTEM MOTION DETECTOR SECURITY SYSTEM DOOR POSITION SWITCH SECURITY SYSTEM GLASS BREAK DETECTION PUSHBUTTON STATION  VOICE/DATA SYMBOLS WIRELESS ACCESS POINT, (2) CAT6A UTP 1 PORT, WALL MOUNT, (1) CAT6 UTP 2 PORT, WALL MOUNT, (2) CAT6 UTP	48" CEILING 144" 48" 48" CEILING CEILING 20" 20"
AUDIO/VIS	SECURITY SYMBOLS  PUSHBUTTON STATION INTERIOR SECURITY SYSTEM CAMERA EXTERIOR SECURITY SYSTEM CAMERA, "PTZ" = PAN, TILT, ZOOM SECURITY SYSTEM CARD READER INTERCOM; MASTER, SLAVE STATION SECURITY SYSTEM KEY PAD SECURITY SYSTEM MOTION DETECTOR SECURITY SYSTEM DOOR POSITION SWITCH SECURITY SYSTEM GLASS BREAK DETECTION PUSHBUTTON STATION  VOICE/DATA SYMBOLS WIRELESS ACCESS POINT, (2) CAT6A UTP 1 PORT, WALL MOUNT, (1) CAT6 UTP 2 PORT, WALL MOUNT, (2) CAT6 UTP 4 PORT, WALL MOUNT, (3) CAT6 UTP CEILING MOUNT	48" CEILING 144" 48" 48" CEILING CEILING 20" 20" 20"
AUDIO/VIS	SECURITY SYMBOLS  PUSHBUTTON STATION INTERIOR SECURITY SYSTEM CAMERA EXTERIOR SECURITY SYSTEM CAMERA, "PTZ" = PAN, TILT, ZOOM SECURITY SYSTEM CARD READER INTERCOM; MASTER, SLAVE STATION SECURITY SYSTEM KEY PAD SECURITY SYSTEM MOTION DETECTOR SECURITY SYSTEM DOOR POSITION SWITCH SECURITY SYSTEM GLASS BREAK DETECTION PUSHBUTTON STATION  VOICE/DATA SYMBOLS WIRELESS ACCESS POINT, (2) CAT6A UTP 1 PORT, WALL MOUNT, (1) CAT6 UTP 2 PORT, WALL MOUNT, (3) CAT6 UTP 4 PORT, WALL MOUNT, (4) CAT6 UTP	48" CEILING 144" 48" 48" CEILING CEILING 20" 20" 20" 20"

REFER TO DETAIL SHEETS FOR MORE INFORMATION

		CAMERA SCHEDULE	<u> </u>		
NUMBER	TYPE	MOUNTING	ENVIRONMENT	DESCRIPTION	SHEET
01	#11 OUTDOOR 360	WALL-MOUNTED VERTICALLY AT 12'	EXTERIOR	SW CORNER	T-201
02	#11 OUTDOOR 360	WALL-MOUNTED VERTICALLY AT 12'	EXTERIOR	WEST WALL	T-201
03	#7 2MP OUTDOOR BULLET	WALL-MOUNTED VERTICALLY AT 12'	EXTERIOR	VESTIBULE	T-201
04	#11 OUTDOOR 360	WALL-MOUNTED VERTICALLY AT 12'	EXTERIOR	WEST WALL	T-201
05	#11 OUTDOOR 360	WALL-MOUNTED VERTICALLY AT 12'	EXTERIOR	NW CORNER	T-201
06	#7 2MP OUTDOOR BULLET	WALL-MOUNTED VERTICALLY AT 12'	EXTERIOR	NORTH WALL	T-201
07	#11 OUTDOOR 360	WALL-MOUNTED VERTICALLY AT 12'	EXTERIOR	NE CORNER SMALL MEETING	T-201
08	#11 OUTDOOR 360	WALL-MOUNTED VERTICALLY AT 12'	EXTERIOR	NE CORNER PROGRAM SPACE	T-201
09	#11 OUTDOOR 360	WALL-MOUNTED VERTICALLY AT 12'	EXTERIOR	SE CORNER PROGRAM SPACE	T-201
10	#11 OUTDOOR 360	WALL-MOUNTED VERTICALLY AT 12'	EXTERIOR	SE CORNER TWEEN ZONE	T-201
11	#8 360-DEGREE FISHEYE	CEILING-MOUNTED	INTERIOR	WELCOME ZONE	T-201
12	#4 2MP VARIFOCAL INDOOR DOME	CEILING-MOUNTED	INTERIOR	SEATING AREA	T-201
13	#4 2MP VARIFOCAL INDOOR DOME	CEILING-MOUNTED	INTERIOR	CUST SERVICE DESK	T-201
14	#4 2MP VARIFOCAL INDOOR DOME	WALL-MOUNTED VERTICALLY AT 7' 8" AFG	INTERIOR	RESTROOM CORRIDOR	T-201
15	#4 2MP VARIFOCAL INDOOR DOME	CEILING-MOUNTED	INTERIOR	HOMEWORK HELP	T-201
16	#4 2MP VARIFOCAL INDOOR DOME	CEILING-MOUNTED	INTERIOR	TWEEN ZONE	T-201
17	#4 2MP VARIFOCAL INDOOR DOME	CEILING-MOUNTED	INTERIOR	TWEEN ZONE	T-201
18	#4 2MP VARIFOCAL INDOOR DOME	WALL-MOUNTED VERTICALLY AT 7' 8" AFG	INTERIOR	STAIR 1	T-201
19	#4 2MP VARIFOCAL INDOOR DOME	WALL-MOUNTED VERTICALLY AT 7' 8" AFG	INTERIOR	ELEVATORS	T-201
20	#4 2MP VARIFOCAL INDOOR DOME	WALL-MOUNTED VERTICALLY AT 7' 8" AFG	INTERIOR	WELCOME ZONE	T-201
21	#4 2MP VARIFOCAL INDOOR DOME	WALL-MOUNTED VERTICALLY AT 7' 8" AFG	INTERIOR	ELEVATOR LOBBY	T-201
22	#4 2MP VARIFOCAL INDOOR DOME	CEILING-MOUNTED	INTERIOR	LARGE MEETING	T-201
23	#4 2MP VARIFOCAL INDOOR DOME	CEILING-MOUNTED	INTERIOR	KIDS ZONE CORRIDOR	T-201
24	#4 2MP VARIFOCAL INDOOR DOME	CEILING-MOUNTED	INTERIOR	SMALL MEETING	T-201
25	#4 2MP VARIFOCAL INDOOR DOME	CEILING-MOUNTED	INTERIOR	SMALL MEETING	T-201
26	#4 2MP VARIFOCAL INDOOR DOME	WALL-MOUNTED VERTICALLY AT 7' 8" AFG	INTERIOR	STAIR 3	T-201
27	#4 2MP VARIFOCAL INDOOR DOME	CEILING-MOUNTED	INTERIOR	PROGRAM SPACE	T-201
28	#4 2MP VARIFOCAL INDOOR DOME	CEILING-MOUNTED	INTERIOR	QUIET ZONE	T-202
29	#4 2MP VARIFOCAL INDOOR DOME	CEILING-MOUNTED	INTERIOR	QUIET ZONE	T-202
30	#4 2MP VARIFOCAL INDOOR DOME	WALL-MOUNTED VERTICALLY AT 7' 8" AFG	INTERIOR	STAIR 1	T-202
31	#4 2MP VARIFOCAL INDOOR DOME	CEILING-MOUNTED	INTERIOR	COMMODITY COMPUTING	T-202
32	#9 180-DEGREE CAMERA	WALL-MOUNTED VERTICALLY AT 7' 8" AFG	INTERIOR	PERIODICALS N WALL	T-202
33	#4 2MP VARIFOCAL INDOOR DOME	CEILING-MOUNTED	INTERIOR	STUDY RMS	T-202
34	#4 2MP VARIFOCAL INDOOR DOME	CEILING-MOUNTED	INTERIOR	STUDY RMS	T-202
35	#4 2MP VARIFOCAL INDOOR DOME	CEILING-MOUNTED	INTERIOR	TEEN ZONE	T-202
36	#4 2MP VARIFOCAL INDOOR DOME	CEILING-MOUNTED	INTERIOR	TEEN ZONE	T-202
37	#9 180-DEGREE CAMERA	WALL-MOUNTED VERTICALLY AT 7' 8" AFG	INTERIOR	COLLECTIONS N WALL	T-202
38	#4 2MP VARIFOCAL INDOOR DOME	WALL-MOUNTED VERTICALLY AT 7' 8" AFG	INTERIOR	STAIR 3	T-202
39	#4 2MP VARIFOCAL INDOOR DOME	WALL-MOUNTED VERTICALLY AT 7' 8" AFG	INTERIOR	E READING CHAIRS	T-202
40	#4 2MP VARIFOCAL INDOOR DOME	WALL-MOUNTED VERTICALLY AT 7' 8" AFG	INTERIOR	COLLECTIONS S WALL	T-202
41	#10 DUAL-SENSOR CAMERA	CEILING-MOUNTED	INTERIOR	MAIN STAIR	T-202
42	#9 180-DEGREE CAMERA	WALL-MOUNTED VERTICALLY AT 7' 8" AFG	INTERIOR	PERIODICALS S WALL	T-202
43	#4 2MP VARIFOCAL INDOOR DOME	WALL-MOUNTED VERTICALLY AT 7' 8" AFG	INTERIOR	W READING CHAIRS	T-202
44	#11 OUTDOOR 360	POLE-MOUNTED VERTICALLY AT 14'	EXTERIOR	PARKING LOT (REFER TO SITE PLAN)	T-001
45	#11 OUTDOOR 360	POLE-MOUNTED VERTICALLY AT 14'	EXTERIOR	PARKING LOT (REFER TO SITE PLAN)	T-001
46	#11 OUTDOOR 360	POLE-MOUNTED VERTICALLY AT 14'	EXTERIOR	PARKING LOT (REFER TO SITE PLAN)	T-001
47	#11 OUTDOOR 360	POLE-MOUNTED VERTICALLY AT 14'	EXTERIOR	PARKING LOT (REFER TO SITE PLAN)	T-001

KORDA/NEMETH ENGINEERING
1650 WATERMARK DRIVE
SUITE 200
COLUMBUS, OHIO 43215
DRAWN BY: Garrett W. Strauss
DESIGNED BY: Prairie S. Gallina
CHECKED BY: Checker
PROJECT NUMBER: 2021-0529

COLUMBUS METROPOLITAN LIBRARY

CONSTRUCTION MANAGER:
TURNER CONSTRUCTION COMPANY 262 HANOVER ST COLUMBUS, OH 614-984-3000

STRUCTURAL ENGINEER: KORDA/ NEMETH ENGINEERING, INC 1650 WATERMARK DR. STE 200 COLUMBUS, OH 43215 614-487-1650

MECHANICAL/ ELECTRICAL: KORDA/ NEMETH ENGINEERING, INC 1650 WATERMARK DR. STE 200 COLUMBUS, OH 43215 614-487-1650

GAHANNA

CONSTRUCTION **DOCUMENTS** 

3/9/2022

MARK DATE DESCRIPTION PROJECT ARCHITECT KNE PROJECT NUMBER 102327

TECHNOLOGY SYMBOLS AND LEGENDS

SHEET NUMBER T-000

PLAN NORTH



COLUMBUS METROPOLITAN LIBRARY

CONSTRUCTION MANAGER: TURNER CONSTRUCTION COMPANY 262 HANOVER ST

STRUCTURAL ENGINEER: KORDA/ NEMETH ENGINEERING, INC 1650 WATERMARK DR. STE 200

MECHANICAL/ ELECTRICAL: KORDA/ NEMETH ENGINEERING, INC 1650 WATERMARK DR. STE 200 COLUMBUS, OH 43215 614-487-1650


**GAHANNA** BRANCH LIBRARY


CONSTRUCTION DOCUMENTS

3/9/2022

102327

TECHNOLOGY

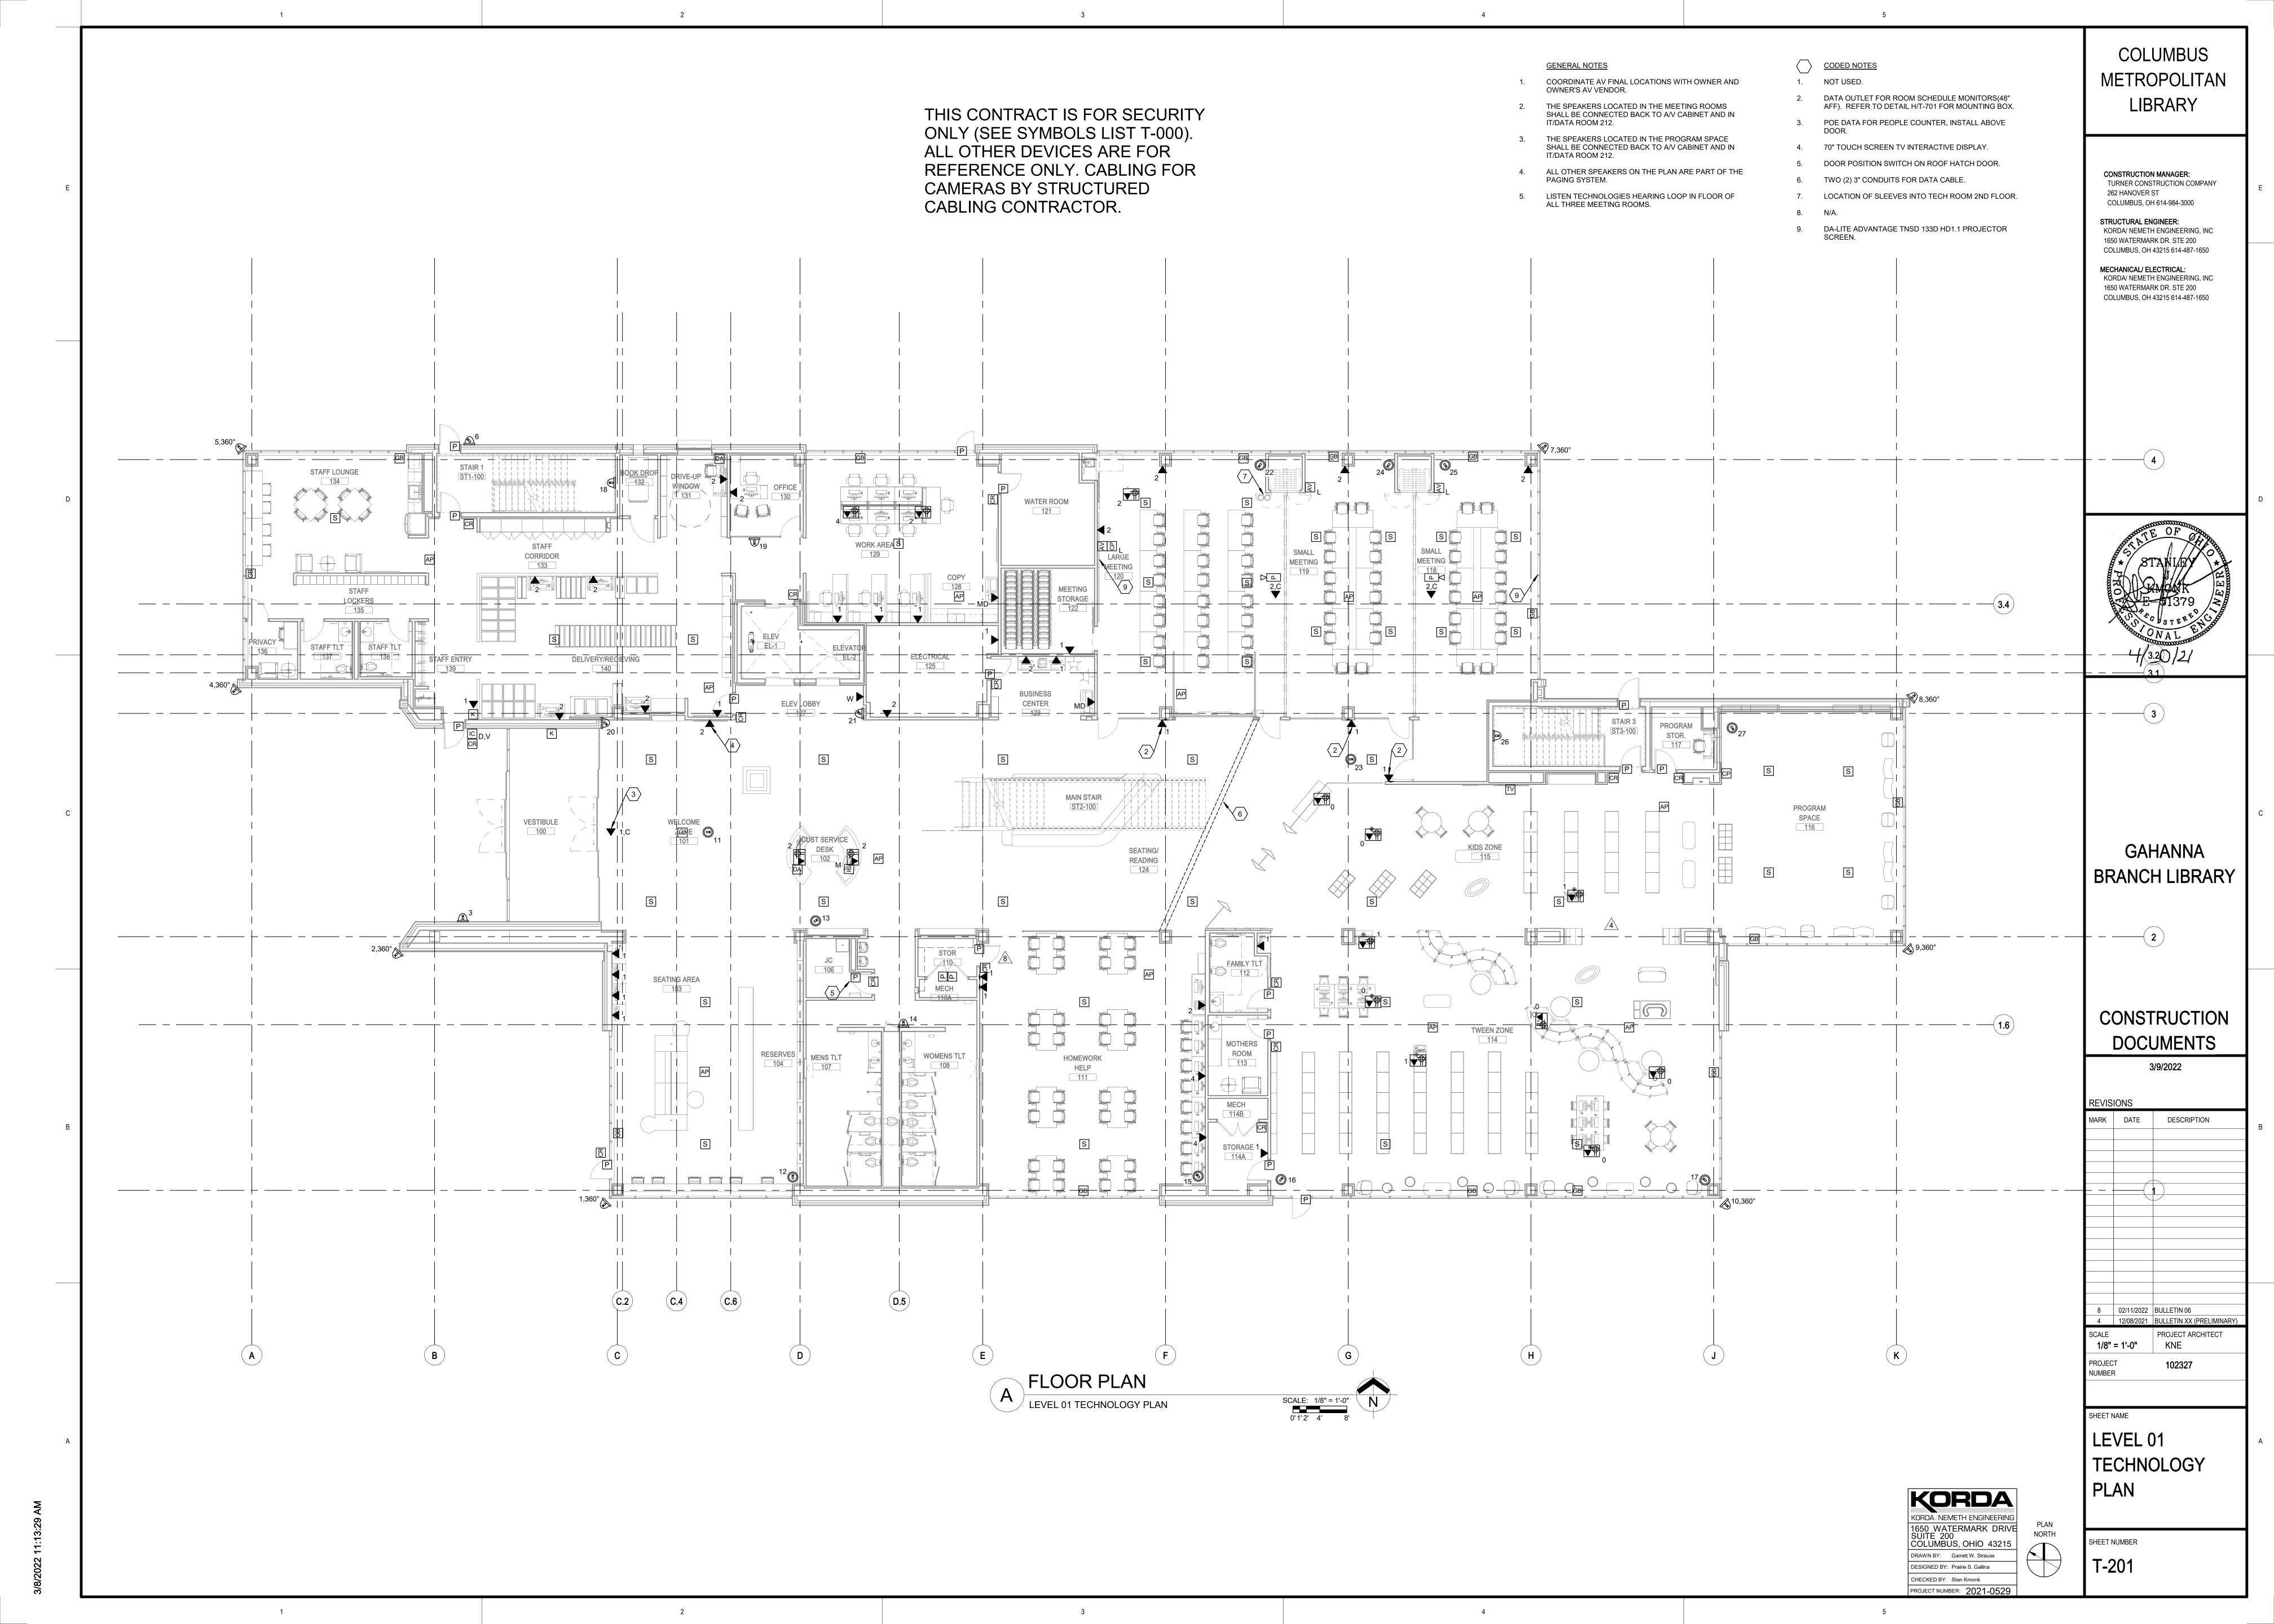

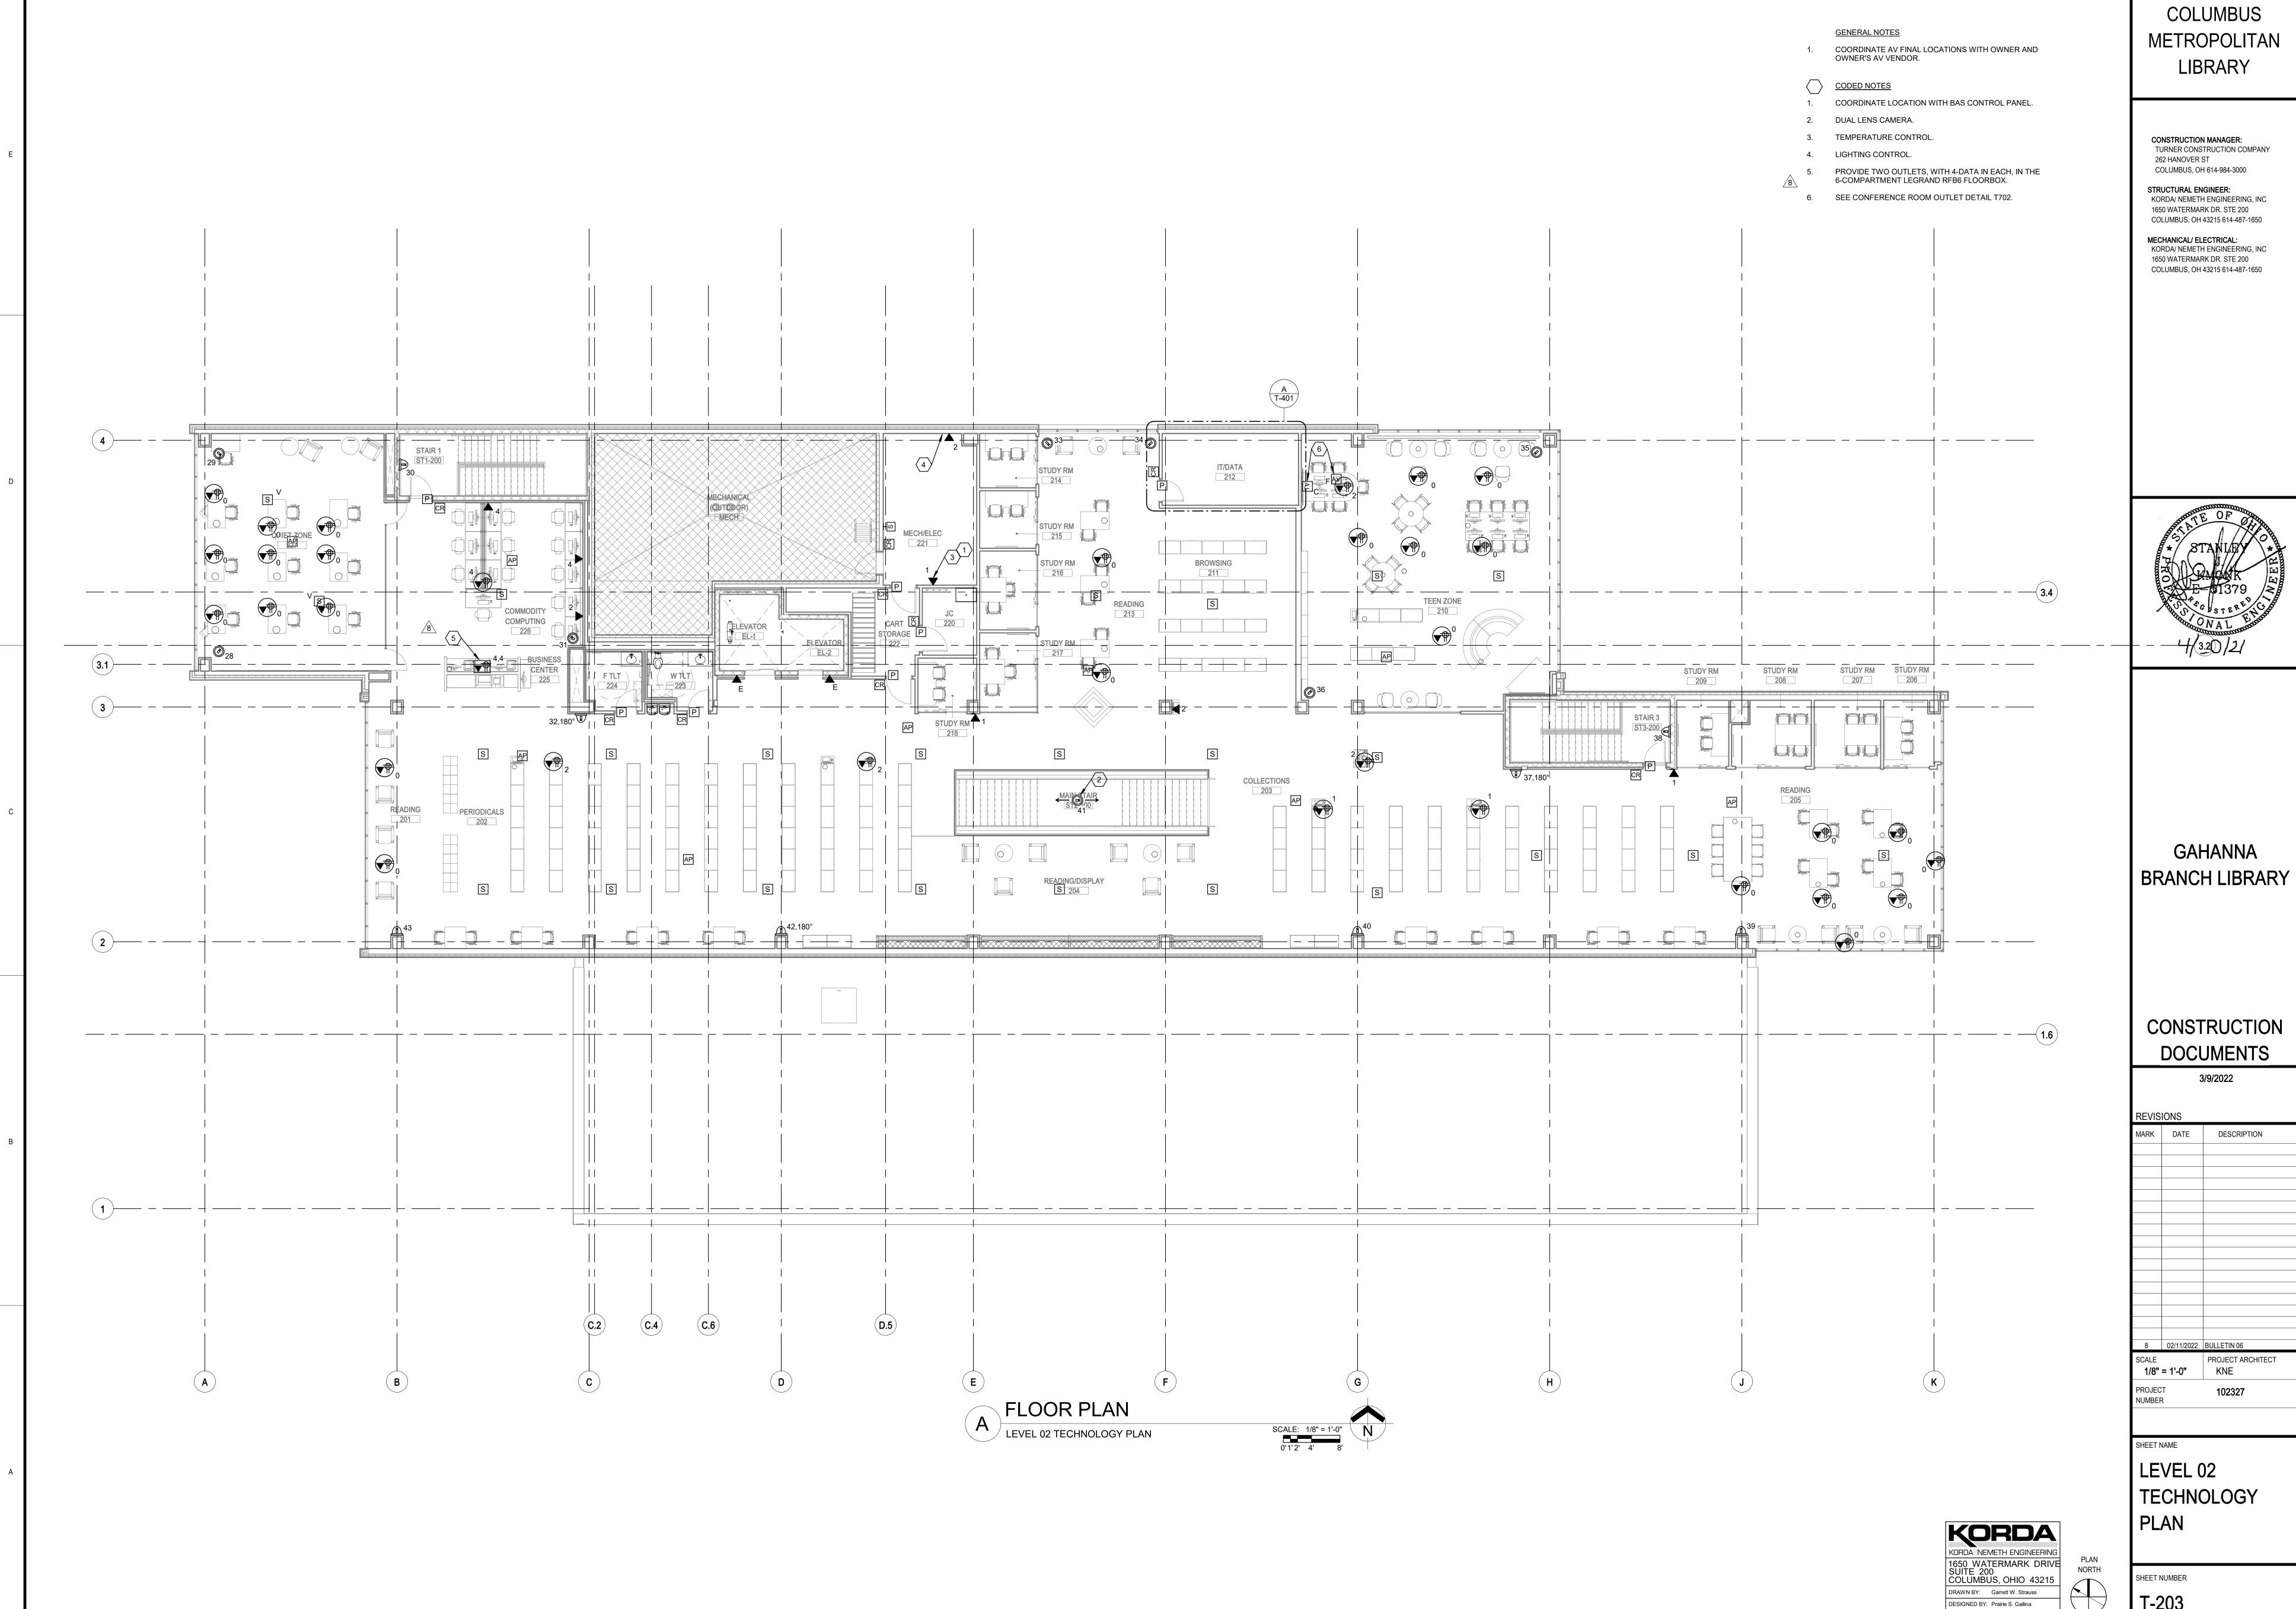


T-203


CHECKED BY: Checker

PROJECT NUMBER: 2021-0529

THIS CONTRACT IS FOR SECURITY ONLY (SEE SYMBOLS LIST T-000). ALL OTHER DEVICES ARE FOR REFERENCE ONLY. CABLING FOR CAMERAS BY STRUCTURED CABLING CONTRACTOR.

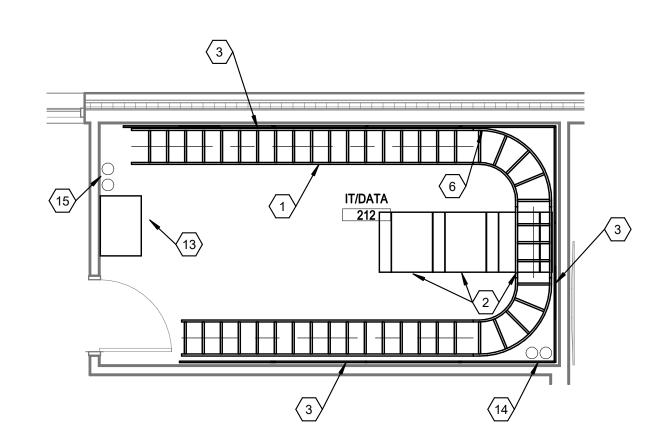



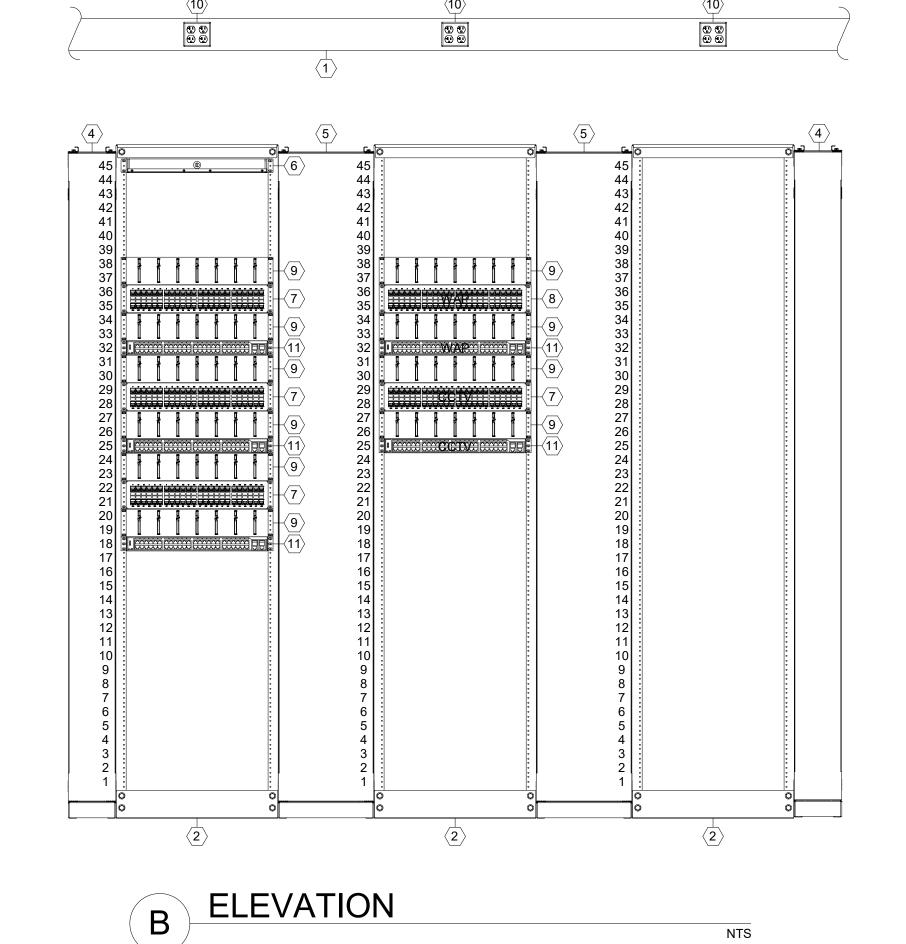

CODED NOTES


- 1. 18" LADDER RACK.
- 4-POST EQUIPMENT RACK.
- 3. PLYWOOD BACKBOARD.
- 4. 6" WIDE VERTICAL CABLE MANAGEMENT.
- 5. 8" WIDE VERTICAL CABLE MANAGEMENT.
- MAIN TECHNOLOGY GROUNDING BUSBAR.
- 7. 2U 48 PORT CAT-6 PATCH PANEL.
- 8. 2U 48 PORT CAT-6A PATCH PANEL. 9. 2U HORIZONTAL CABLE MANAGER.
- 10. SURFACE MOUNTED ELECTRICAL RECEPTACLE AND CONDUIT SHALL BE CLAMPED TO SIDE OF LADDER
- NETWORK ELECTRONICS BY OWNER.
- 12. ACCESS CONTROL PANEL LOCATION.
- 13. AV EQUIPMENT RACK FOR 1ST FLOOR MEETING ROOMS. INSTALLED BY OWNER AV CONTRACTOR.
- 14. TWO (2) 4" SLEEVES FROM 1ST FLOOR CEILING FOR COMMUNICATIONS CABLE FROM 1ST FLOOR.
   15. TWO (2) CONDUITS FOR INTERNET AND PHONE FROM THE COMMUNICATIONS SUPPLIER (SPECTRUM).

COLUMBUS METROPOLITAN LIBRARY

CONSTRUCTION MANAGER: TURNER CONSTRUCTION COMPANY 262 HANOVER ST COLUMBUS, OH 614-984-3000

STRUCTURAL ENGINEER: KORDA/ NEMETH ENGINEERING, INC 1650 WATERMARK DR. STE 200 COLUMBUS, OH 43215 614-487-1650

MECHANICAL/ ELECTRICAL: KORDA/ NEMETH ENGINEERING, INC 1650 WATERMARK DR. STE 200 COLUMBUS, OH 43215 614-487-1650

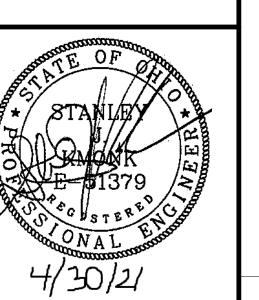

**GAHANNA** BRANCH LIBRARY

CONSTRUCTION DOCUMENTS

3/9/2022


1/4" = 1'-0" KNE

NUMBER


TECHNOLOGY ENLARGED PLANS

SHEET NUMBER T-401


KORDA/NEMETH ENGINEERING
1650 WATERMARK DRIVE
SUITE 200
COLUMBUS, OHIO 43215 PLAN NORTH DRAWN BY: Garrett W. Strauss DESIGNED BY: Prairie S. Gallina CHECKED BY: Checker PROJECT NUMBER: 2021-0529

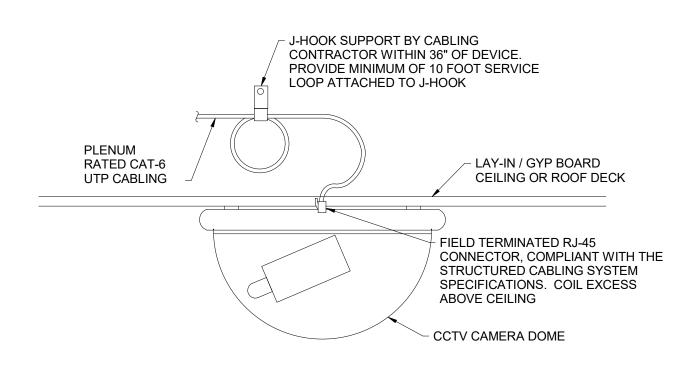


CCTV CAMERA - DIRECT ATTACH CONNECTION (f)

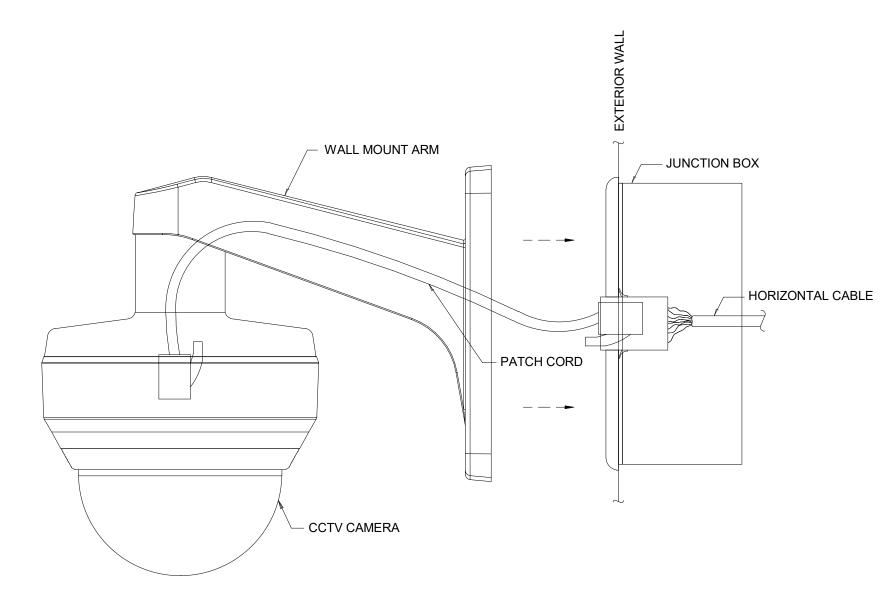

EXTERIOR CCTV CAMERA - STANDARD CONNECTION (B)

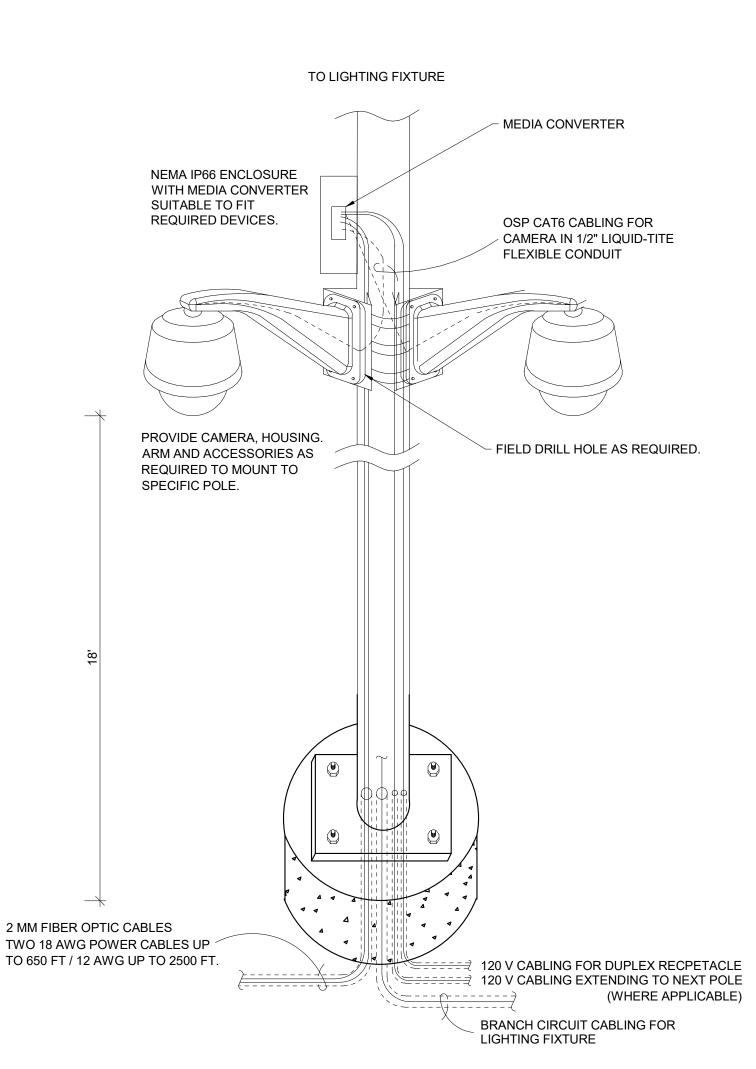

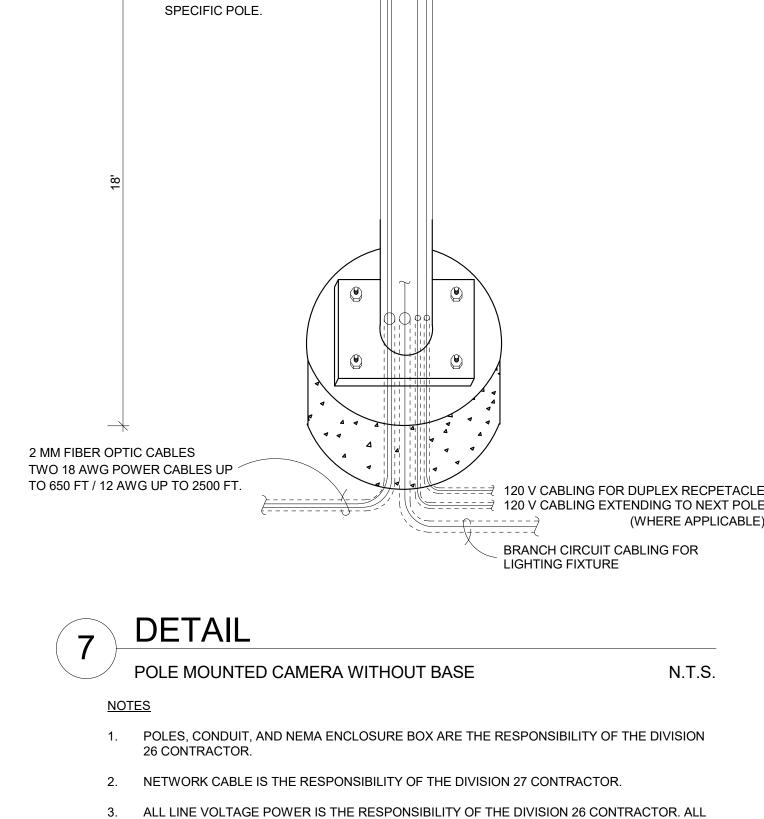


LOW VOLTAGE POWER IS THE RESPONSIBILITY OF THE DIVISION 27 CONTRACTOR.


4. CAMERA AND EITHER ETHERNET EXTENDER OR MEDIA CONVERTOR ARE THE

RESPONSIBILITY OF THE DIVISION 28 CONTRACTOR.


. CAMERA HOUSING SHALL BE PAINTED TO MATCH POLE.

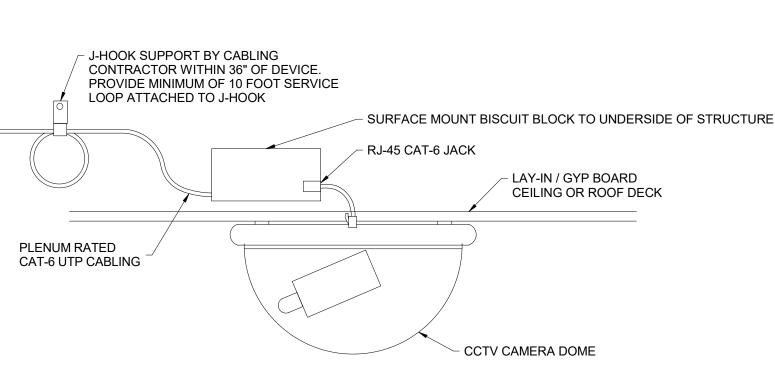

N.T.S. CCTV CAMERA - STANDARD CONNECTION (§)

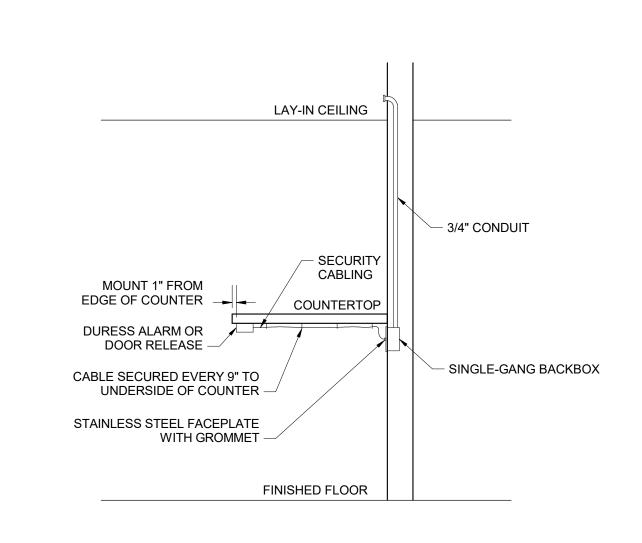

DURESS ALARM / DOOR RELEASE N.T.S.

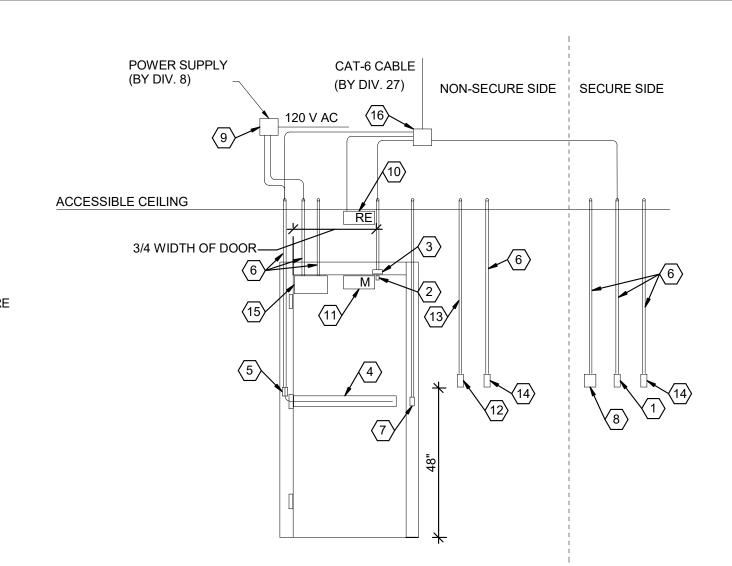

SINGLE DOOR SECURITY DEVICE

N.T.S.

**GENERAL NOTES** 

1. EACH DOOR DOES NOT CONTAIN EACH DEVICE DEPICTED. SEE DOOR HARDWARE SCHEDULE AND FLOOR PLANS FOR MORE INFORMATION.

CODED NOTES

1. CARD READER BY DIV. 28. BACKBOX BY DIV. 26.

2. DOOR CONTACT BY DIV. 28.

3. BACKBOX AND 3/4" CONDUIT FROM BACKBOX TO ABOVE ACCESSIBLE CEILING BY DIV. 26. UTILIZE FOR DOOR CONTACT (AND MAG LOCK IF APPLICABLE).

4. ELECTRIC CRASH BAR (IF APPLICABLE) INSTALLED BY DIV. 8 AND WIRED TO POWER SUPPLY BY DIV. 28.

5. BACKBOX MOUNTED IN DOOR FRAME (IF ELECTRIC CRASH BAR UTILIZED) BY DIV. 26.

FOR DOOR STRIKE (IF APPLICABLE) BY DIV. 26.

6. 3/4" CONDUIT FROM BACKBOX TO ABOVE CEILING (IF DEVICE UTILIZED) BY DIV. 26.

7. BACKBOX AND 3/4" CONDUIT FROM TO ABOVE ACCESSIBLE CEILING

8. KEYPAD BY DIV. 28. 4- SQUARE MASONRY BACKBOX BY DIV. 26.

9. POWER SUPPLY INSTALLED AND WIRED TO 120 V AC BY DIV. 26.

10. REQUEST TO EXIT MOTION DETECTOR (IF APPLICABLE) BY DIV. 28. MOUNT TO CEILING CENTERED ABOVE DOORWAY WHENEVER POSSIBLE. IF CEILING MOUNT IS NOT POSSIBLE WALL MOUNT WITH A SINGLE GANG BOX AT 108" AND EXTEND A 3/4" CONDUIT TO ABOVE ACCESSIBLE CEILING BY DIV. 26.

11. MAGNETIC DOOR LOCK (IF APPLICABLE) BY DIV. 8. UTILIZE SAME CONDUIT AS DOOR CONTACT. PROVIDE FIRE ALARM TIE IN TO RELEASE MAG LOCK UPON ACTIVATION OF FIRE ALARM.


12. REQUEST TO EXIT BUTTON (IF APPLICABLE) BY DIV. 28. SINGLE GANG MASONRY BACKBOX (IF APPLICABLE) BY DIV. 26.

13. 3/4" CONDUIT FROM BACKBOX TO ABOVE ACCESSIBLE CEILING (IF MAG LOCK UTILIZED) BY DIV. 26.

14. WALL ACTUATOR STATION FOR DOOR OPERATOR BY DIV 8. SINGLE GANG MASONRY BACKBOX BY DIV. 26.

15. POWER OPERATED DOOR OPERATOR (IF WALL ACTIVATOR UTILIZED)

BY DIV. 8. 16. DOOR CONTROLLER BY DIV. 28.

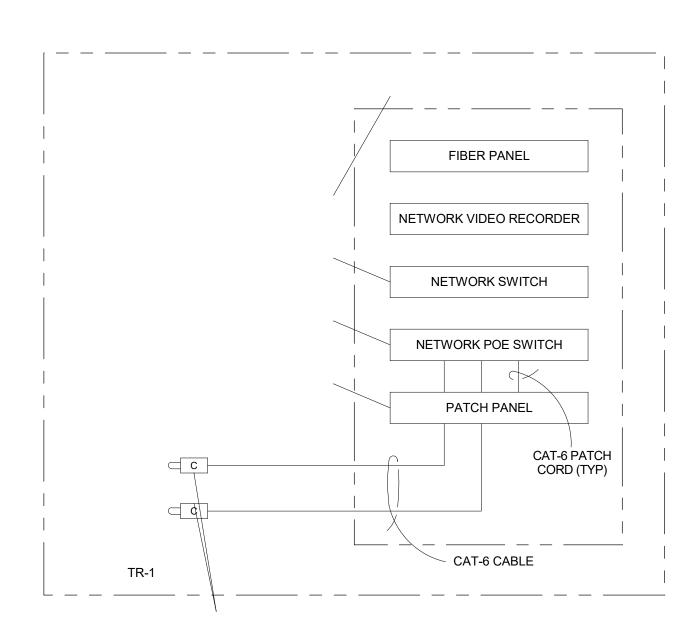

<u>NOTES</u>

IP VIDEO SURVEILLANCE RISER


1. CONTRACTOR SHALL VERIFY CABLING REQUIREMENTS PRIOR TO INSTALLATION.

2. DIAGRAM IS FOR REFERENCE ONLY. CONTRACTOR SHALL SUBMIT FOR APPROVAL A SPECIFIC DIAGRAM.

N.T.S.

3. CONTRACTOR SHALL COORDINATE EXACT POWER SUPPLY CONNECTIONS AND CIRCUIT TO UPS.

4. CONTRACTOR SHALL SUPPLY ALL PATCH CABLES AND INTERCONNECTIONS OF THE SYSTEM COMPLY WITH SECTION 27 10 00

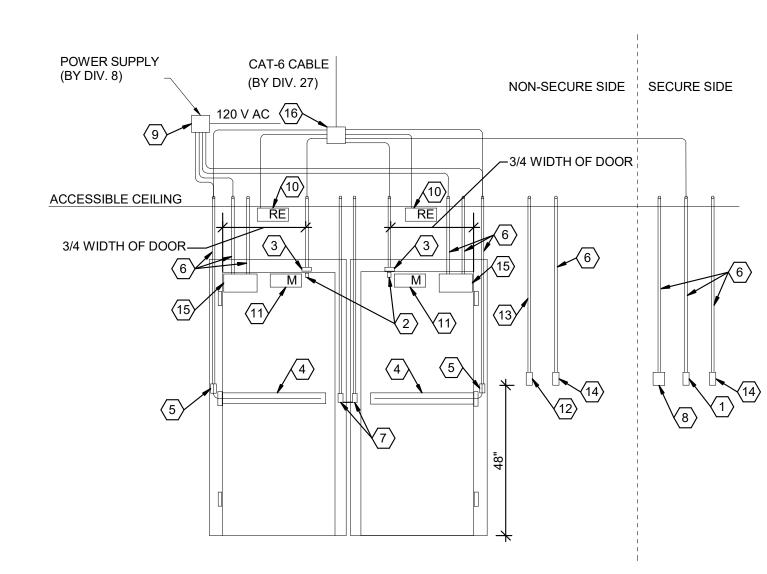

DOUBLE DOOR SECURITY DEVICE

N.T.S.

**GENERAL NOTES** 

1. EACH DOOR DOES NOT CONTAIN EACH DEVICE DEPICTED. SEE DOOR HARDWARE SCHEDULE AND FLOOR PLANS FOR MORE INFORMATION.

CODED NOTES

1. CARD READER BY DIV. 28. BACKBOX BY DIV. 26.

DOOR CONTACT BY DIV. 28.

3. BACKBOX AND 3/4" CONDUIT FROM BACKBOX TO ABOVE ACCESSIBLE CEILING BY DIV. 26. UTILIZE FOR DOOR CONTACT (AND MAG LOCK IF APPLICABLE).

4. ELECTRIC CRASH BAR (IF APPLICABLE) INSTALLED BY DIV. 8 AND WIRED TO POWER SUPPLY BY DIV. 28.

5. BACKBOX MOUNTED IN DOOR FRAME (IF ELECTRIC CRASH BAR

6. 3/4" CONDUIT FROM BACKBOX TO ABOVE CEILING (IF DEVICE UTILIZED)

7. BACKBOX AND 3/4" CONDUIT FROM TO ABOVE ACCESSIBLE CEILING FOR DOOR STRIKE (IF APPLICABLE) BY DIV. 26.

8. KEYPAD BY DIV. 28. 4- SQUARE MASONRY BACKBOX BY DIV. 26.

9. POWER SUPPLY INSTALLED AND WIRED TO 120 V AC BY DIV. 26.

10. REQUEST TO EXIT MOTION DETECTOR (IF APPLICABLE) BY DIV. 28. MOUNT TO CEILING CENTERED ABOVE DOORWAY WHENEVER POSSIBLE. IF CEILING MOUNT IS NOT POSSIBLE WALL MOUNT WITH A SINGLE GANG BOX AT 108" AND EXTEND A 3/4" CONDUIT TO ABOVE ACCESSIBLE CEILING BY DIV. 26.

11. MAGNETIC DOOR LOCK (IF APPLICABLE) BY DIV. 8. UTILIZE SAME CONDUIT AS DOOR CONTACT. PROVIDÉ FIRE ALARM TIE IN TO RELEASE MAG LOCK UPON ACTIVATION OF FIRE ALARM.


12. REQUEST TO EXIT BUTTON (IF APPLICABLE) BY DIV. 28. SINGLE GANG MASONRY BACKBOX (IF APPLICABLE) BY DIV. 26.

13. 3/4" CONDUIT FROM BACKBOX TO ABOVE ACCESSIBLE CEILING (IF MAG LOCK UTILIZED) BY DIV. 26.

14. WALL ACTUATOR STATION FOR DOOR OPERATOR BY DIV 8. SINGLE

GANG MASONRY BACKBOX BY DIV. 26. 15. POWER OPERATED DOOR OPERATOR (IF WALL ACTIVATOR UTILIZED)

BY DIV. 8. 16. DOOR CONTROLLER BY DIV. 28.

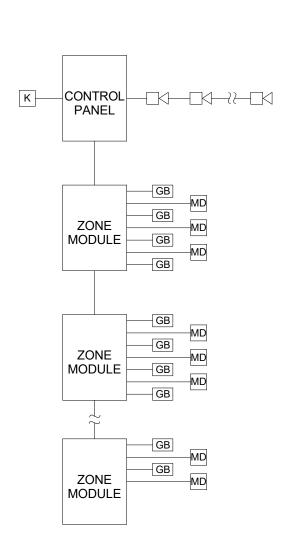

INTRUSION DETECTION RISER

GENERAL NOTES 1. THIS DIAGRAM IS TYPICAL IN NATURE. PLEASE REFER TO ACTUAL

2. ALL DEVICES WILL BE PROVIDED IN THE DIVISION 28 SECURITY CONTRACT. CABLING AND CONDUIT PROVIDED BY THE DIVISION 26 ELECTRICAL CONTRACTOR.

SECURITY SYSTEM SUBMITTAL FOR ACTUAL INSTALLATION DETAILS.

3. PROVIDE PLENUM RATED CABLE IN ENCLOSED DROP CEILINGS IN J HOOKS AND ALL EXPOSED CEILING AREAS REQUIRE CONDUIT FROM ABOVE CABLE TRAY TO DEVICE BOX.

4. PROVIDE 18 AWG FOUR (4) CONDUCTOR UNSHIELDED CABLE TO FROM HEAD END ON WALL IN MTR TO ZONE MODULES AND FROM ZONE MODULES TO DEVICES. PROVIDE AT LEAST TWO (2) FEET OF SLACK AT EACH LOCATION. TRY TO GROUP DEVICES IN QUANTITIES OF FOUR (4) OR EIGHT (8) DEVICES PER MODULE. LIMIT RUNS TO 1000'

5. PROVIDE 18 AWG PAIR IN A LOOP FROM HEAD END MOUNTED ON WALL TO ALL HORNS

COLUMBUS LIBRARY CONSTRUCTION MANAGER: TURNER CONSTRUCTION COMPANY 262 HANOVER ST COLUMBUS, OH 614-984-3000 STRUCTURAL ENGINEER: KORDA/ NEMETH ENGINEERING, INC 1650 WATERMARK DR. STE 200 COLUMBUS, OH 43215 614-487-1650

MECHANICAL/ ELECTRICAL:

KORDA/ NEMETH ENGINEERING, INC

COLUMBUS, OH 43215 614-487-1650

1650 WATERMARK DR. STE 200

**GAHANNA** 

CONSTRUCTION **DOCUMENTS** 

3/9/2022

REVISIONS DESCRIPTION

PROJECT ARCHITECT KNE 102327 NUMBER

SHEET NAME

**TECHNOLOGY** DETAILS

KORDA KORDA/NEMETH ENGINEERING 1650 WATERMARK DRIVE SUITE 200 COLUMBUS, OHIO 43215 DRAWN BY: Garrett W. Strauss DESIGNED BY: Prairie S. Gallina

N.T.S.

NORTH CHECKED BY: Checker PROJECT NUMBER: 2021-0529

SHEET NUMBER