


#	DATE	CHANGE DESCRIPTION

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 COLUMBUS, OH 43211
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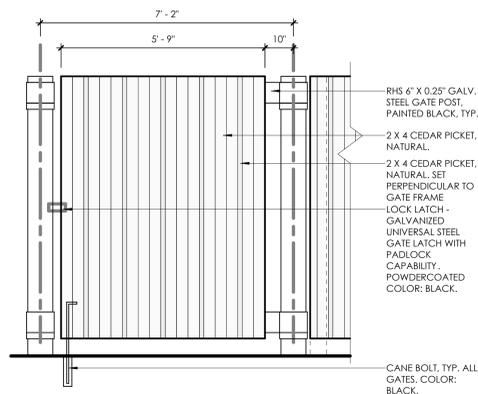
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 300 SPRUCE STREET
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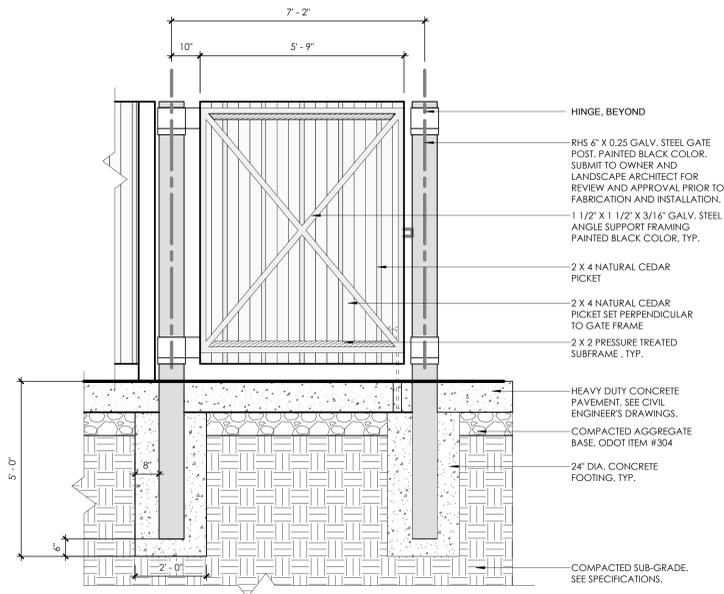
STAIR DETAILS




NOVEMBER, 21, 2023
 DRAWN BY: Author | CHECKED BY: Checker
 22155
L7.4
 PERMIT SET
 Timothy S. Skinner, License # LA.0901208
 Expiration Date 12/31/2024

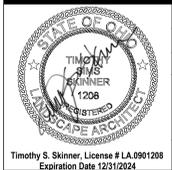


10 STAFF SERVICE DOOR ELEVATION - INTERIOR
1/2" = 1'-0"




7 STAFF SERVICE DOOR ELEVATION - EXTERIOR
1/2" = 1'-0"

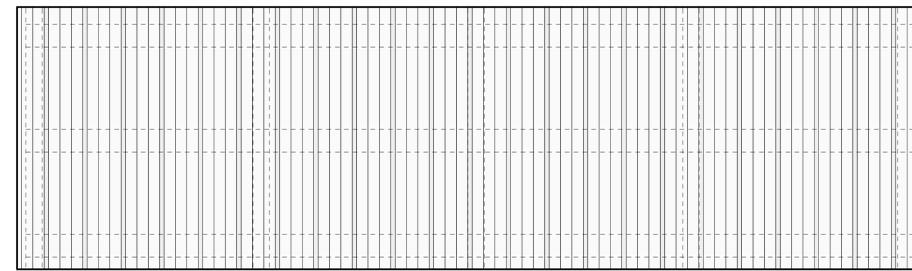


ENCLOSURE FENCING BACK EXTERIOR ELEVATION, TYP.
1/2" = 1'-0"

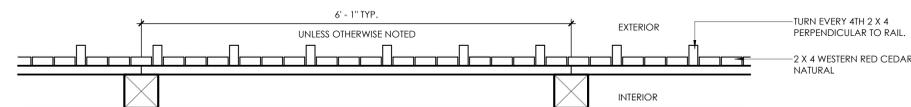


ENCLOSURE SCREEN FENCE ENLARGEMENT PLAN, TYPICAL
1" = 1'-0"

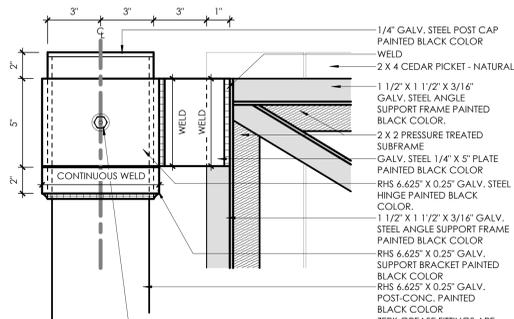


9 HINGE ENLARGEMENT ELEVATION
3" = 1'-0"

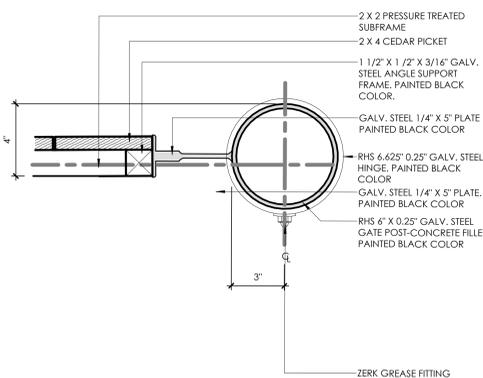


6 HINGE ENLARGEMENT PLAN
3" = 1'-0"

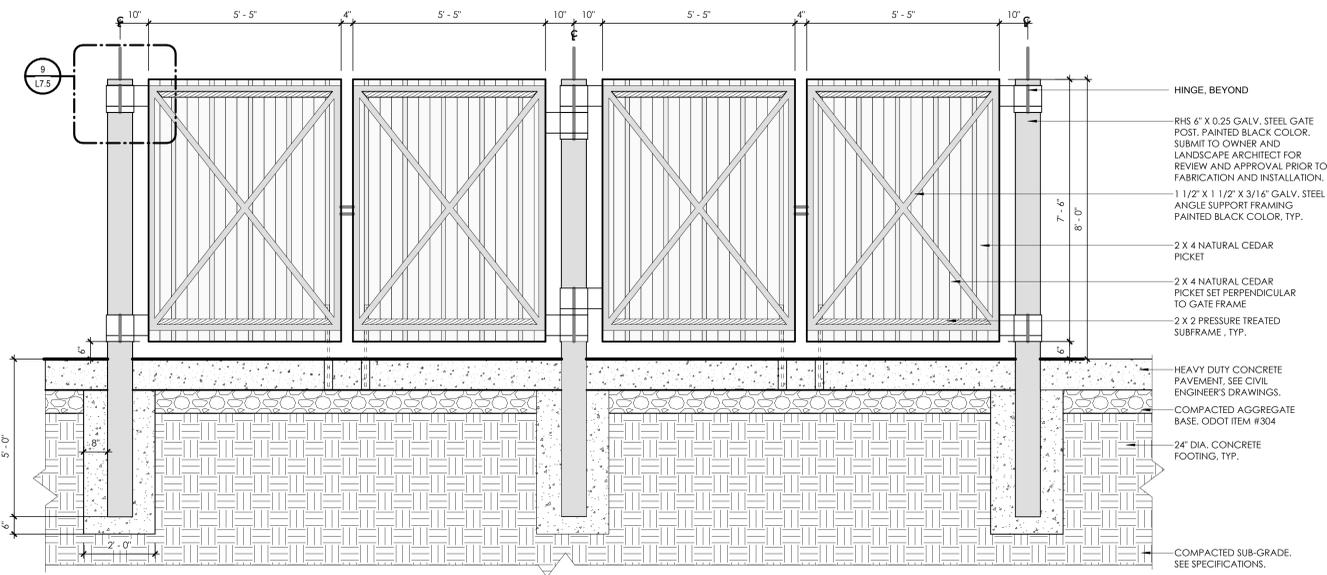


ENCLOSURE GATE ELEVATION - INTERIOR
1/2" = 1'-0"

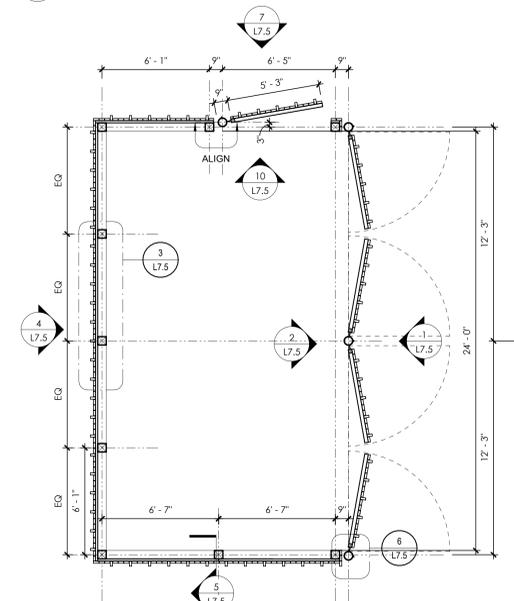

8 REFUSE ENCLOSURE ENLARGEMENT PLAN
1/4" = 1'-0"

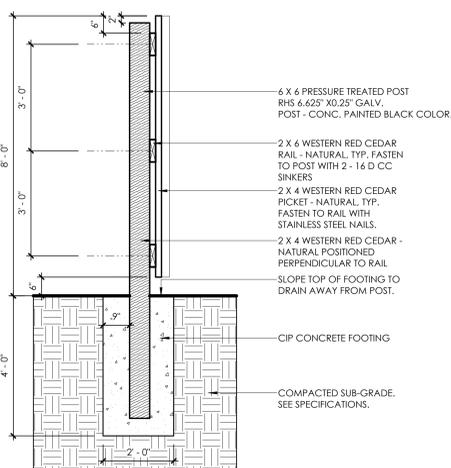

8'-0" TALL ENCLOSURE FENCE DETAIL
1/2" = 1'-0"

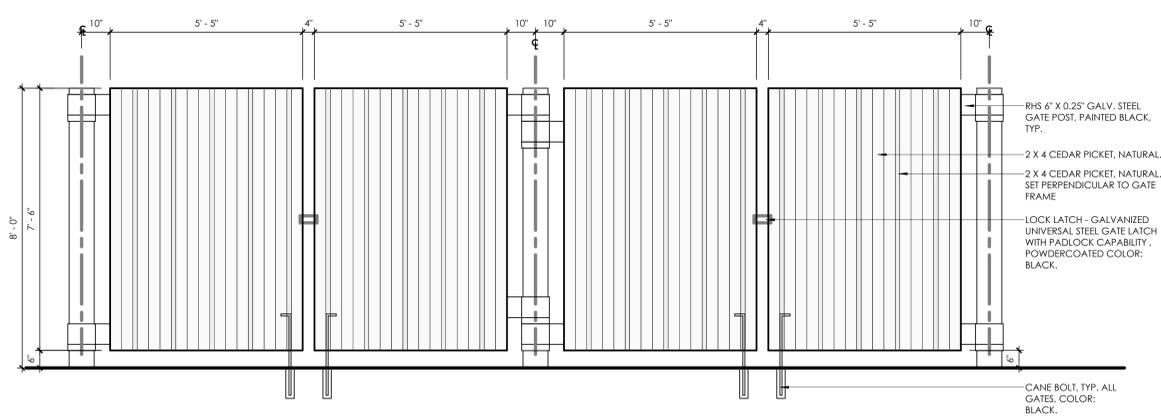


ENCLOSURE GATE ELEVATION - EXTERIOR
1/2" = 1'-0"

#	DATE	CHANGE DESCRIPTION










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REFUSE ENCLOSURE DETAILS



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PLANTING BED PREPARATION SEQUENCE:

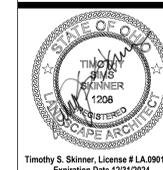1. SCARIFY SUBGRADE 6" DEEP
2. ADD 18" OF PLANTING MIX
3. INSTALL PLANT MATERIAL
4. ADD 3" DEPTH OF DOUBLE SHREDDED HARDWOOD BARK MULCH

PLANTING BED PREPARATION SEQUENCE:

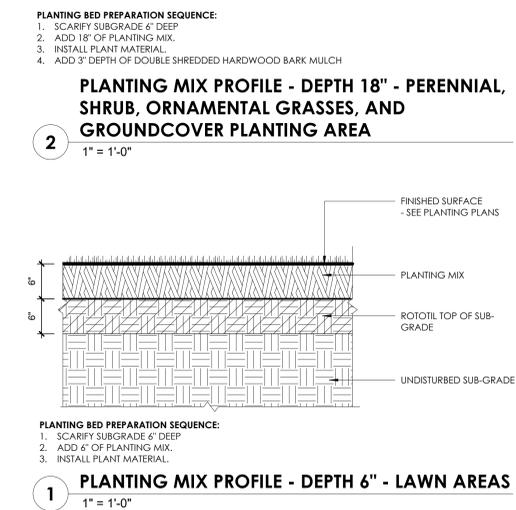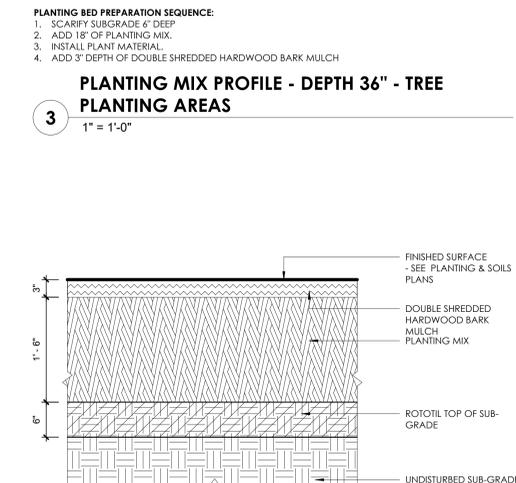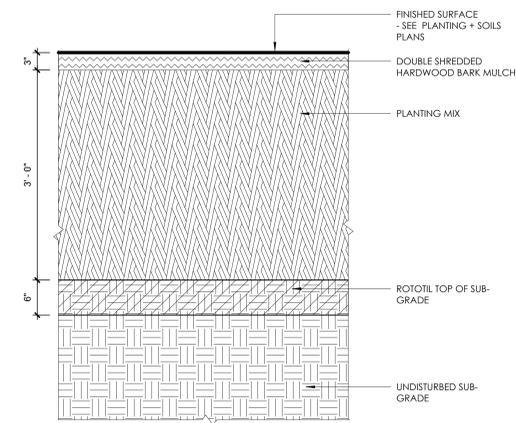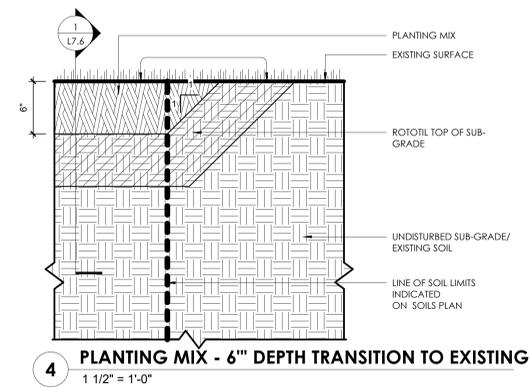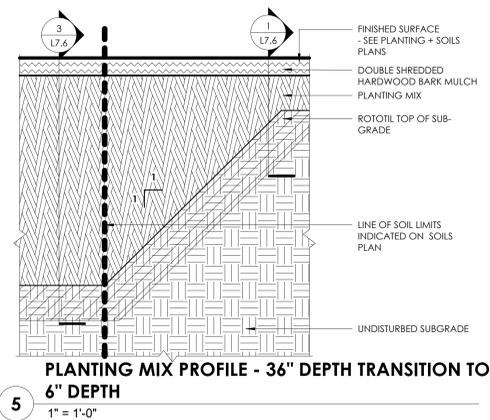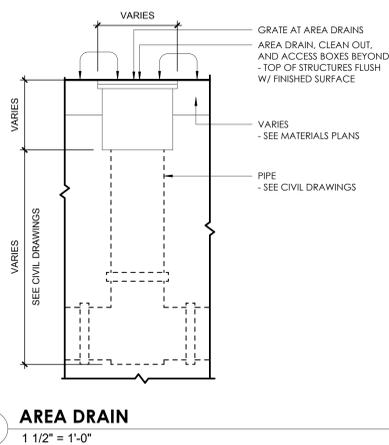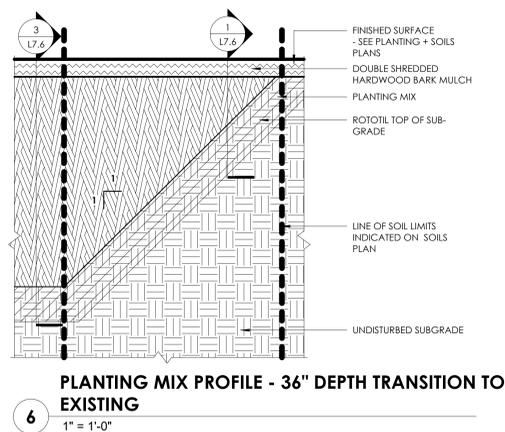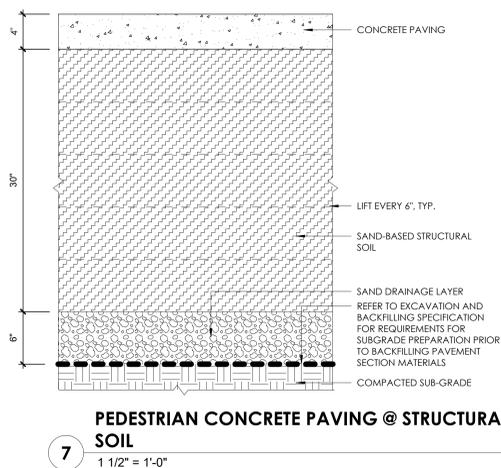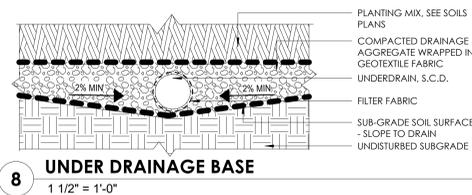1. SCARIFY SUBGRADE 6" DEEP
2. ADD 6" OF PLANTING MIX
3. INSTALL PLANT MATERIAL

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SOILS & DRAINAGE DETAILS

DRAWING TITLE: **SOILS & DRAINAGE DETAILS**

NOVEMBER, 21, 2023

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22155

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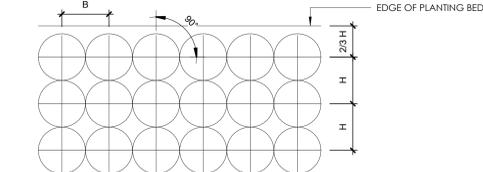
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Timothy S. Skinner, License # LA.0901208
 Expiration Date 12/31/2024

PLANT SCHEDULE


PLANT CODE	BOTANICAL NAME	COMMON NAME	SIZE	CONTAINER	COUNT
Deciduous Trees					
CH	Carpinus caroliniana 'JFS.KW4'	Native Flame American Hornbeam	3" Cal.	B&B	7
GB	Ginkgo biloba 'Princeton Sentry'	Princeton Sentry Ginkgo	3" Cal.	B&B	3
MA	Maackia amurensis	Amur Maackia	3" Cal.	B&B	10
MP	Maclura pomifera 'White Shield'	White Shield Osage Orange	3" Cal.	B&B	6
QR	Quercus rubrum	Red Oak	3" Cal.	B&B	2
UA	Ulmus americana 'Princeton'	Princeton American Elm	3" Cal.	B&B	4
Evergreen Trees					
PG	Picea glauca densata	Black Hills Spruce	8' - 10' HT.	B&B or Cont.	6
PS	Pinus strobus	White Pine	8' - 10' HT.	B&B or Cont.	3
Ornamental Trees					
MV	Magnolia virginiana 'Jim Wilson'	Moonglow Sweetbay Magnolia	2" Cal.	B&B	4
Grasses					
BG	Bouteloua gracilis 'Blande Ambition'	Blande Ambition Blue Grama	#3	Cont.	113
DC	Deschampsia cespitosa	Tufted Hair Grass	#1	Cont.	305
PA	Pennisetum alopecuroides 'Hameiri'	Hameiri Fountain Grass	#3	Cont.	108
Perennials					
EP	Echinacea purpurea	Coneflower	#1	Cont.	106
Shrubs					
CS	Cornus sericea 'Farrow'	Arctic Fire Red Twig Dogwood	#3	Cont.	46
DK	Diervilla x 'G2X885411'	Kodiak Red Diervilla	#3	Cont.	70
JG	Juniperus x 'Grey Owl'	Grey Owl Juniper	24-30" HT.	B&B or Cont.	22
RA	Rhus aromatica 'Gro-Low'	Gro-Low Fragrant Sumac	#3	Cont.	66
TM	Taxus x media 'Everlow'	Everlow Taxus	24-30" HT.	B&B or Cont.	27

ORTHOGONAL SPACING = B	DISTANCE BETWEEN ROWS = H	TOTAL AREA (SF) PER PLANT
6"	6"	0.25
8"	8"	0.50
9"	9"	0.60
10"	10"	0.70
12"	12"	1.00
15"	15"	1.60
18"	18"	2.25
21"	21"	3.00
24"	24"	4.00
30"	30"	6.25
36"	36"	9.00
48"	48"	16.00



12 ORTHOGONAL PLANT SPACING
NOT TO SCALE


SPACING	A	B	C	D	A = SPACING	B = SPACING / 2	C = SPACING / 1.2	D = SPACING
12"	12"	6"	10"	12"				
15"	15"	7.5"	12.5"	15"				
18"	18"	9"	15"	18"				
24"	24"	12"	20"	24"				
36"	36"	18"	30"	36"				
48"	48"	24"	40"	48"				

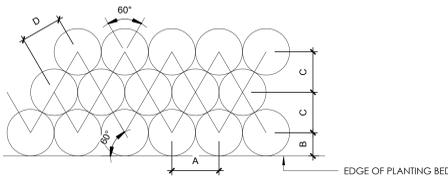


11 TRIANGULAR PLANT SPACING
NOT TO SCALE

SPACING OF PLANTS	NO. OF PLANTS PER SQ. FOOT	AREA ONE PLANT COVERS	NO. OF PLANTS PER 100 SQ. FEET	NO. OF PLANTS PER 1,000 SQ. FEET
6"	4	1/4 SQ. FT.	400	4000
8"	2	1/2 SQ. FT.	200	2000
12"	1	1 SQ. FT.	100	1000
15"	2/3	1 1/2 SQ. FT.	66	660
18"	1/2	2 SQ. FT.	50	500
24"	1/4	4 SQ. FT.	25	250
30"	1/6	6 1/4 SQ. FT.	16	160
36"	1/8	9 SQ. FT.	11	110
48"	1/16	16 SQ. FT.	6	60



10 PLANT SPACING CALCULATIONS PER AREA
NOT TO SCALE

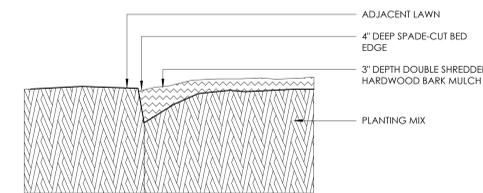

9 PLANTING BED EDGE
6" = 1'-0"


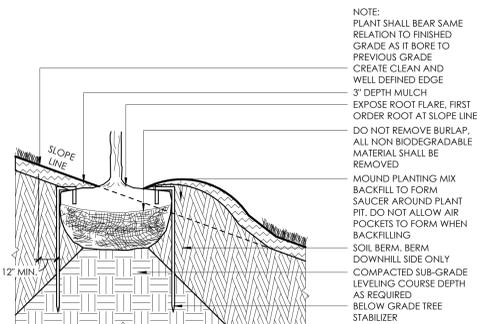


8 TREE STABILIZATION ON SLOPE
3/4" = 1'-0"

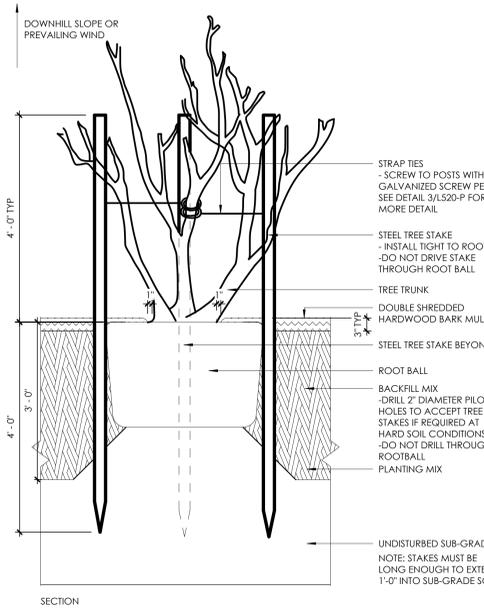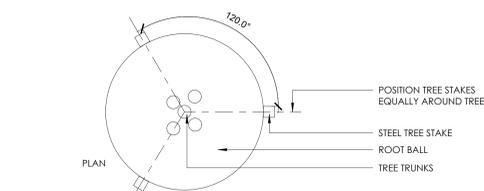


NOTE:
1. LOCATE THE ROOT FLARE. POSITION THE ROOT BALL SUCH THAT THE ROOT FLARE IS 1" ABOVE SOIL SURFACE.
2. STAKE 3 LARGEST STEMS, IF TREE HAS MORE THAN 3 LEADERS
3. ORIENT STAKING / GUYING TO PREVAILING WINDS AND SLOPES, EXCEPT ON SLOPES GREATER THAN 3:1 ORIENT TO SLOPE.
4. USE SAME STAKING / GUYING ORIENTATION FOR ALL PLANTS WITHIN EACH GROUPING OR AREA.

7 TREE STAKING - MULTI-STEM TREE
3/4" = 1'-0"

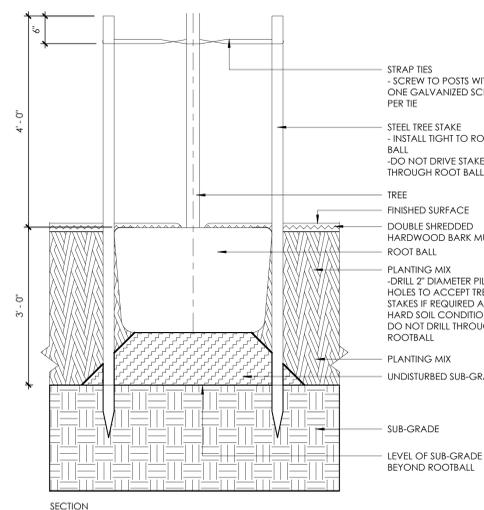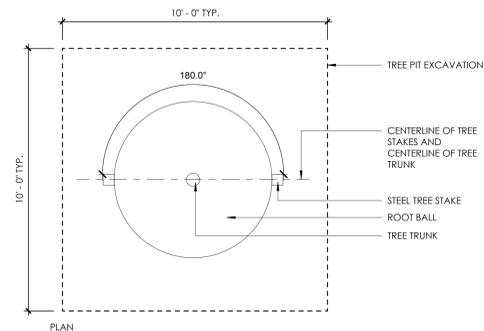


NOTE:
• ORIENT STAKING / GUYING TO PREVAILING WINDS AND SLOPES, EXCEPT ON SLOPES GREATER THAN 3:1 ORIENT TO SLOPE.
• USE SAME STAKING / GUYING ORIENTATION FOR ALL PLANTS WITHIN EACH GROUPING OR AREA.

7 TREE STAKING - SINGLE STEM TREE
3/4" = 1'-0"

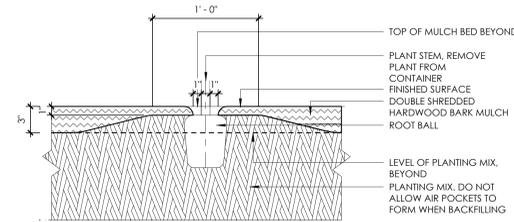


NOTES:
1. CONTAINER PLANTS; REMOVE POTS AND SEPARATE POT BOUND ROOTS AS SPECIFIED.
2. SPACING AS SHOWN ON PLANS AND/OR ON PLANT LISTS.

5 GROUNDCOVER / PERENNIAL PLANTING DETAIL
1 1/2" = 1'-0"

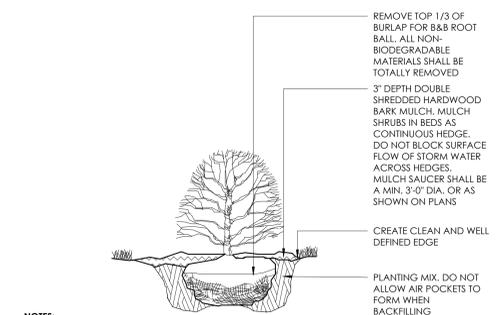


NOTES:
1. DO NOT PRUNE SHRUBS EXCEPT TO REMOVE DEAD OR BROKEN BRANCHES
2. SPACING AS SHOWN ON PLANS OR PLANT LIST

4 SHRUB PLANTING DETAIL
1" = 1'-0"

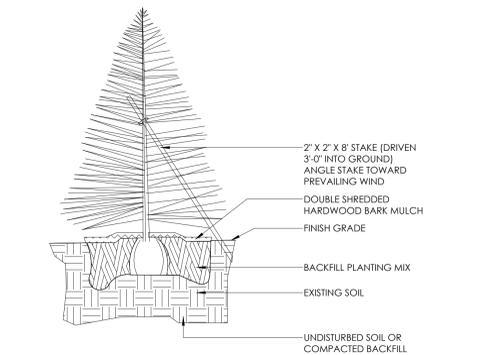


NOTES:
1. TOP OF ROOT BALL TO BE 2'-3" ABOVE ADJACENT FINISH GRADE
2. REMOVE ROPE AND BURLAP FROM TOP 1/3 OF ROOT BALL CUT TOP 1/3 OF WIRE BASKET

3 EVERGREEN TREE
1" = 100'-0"

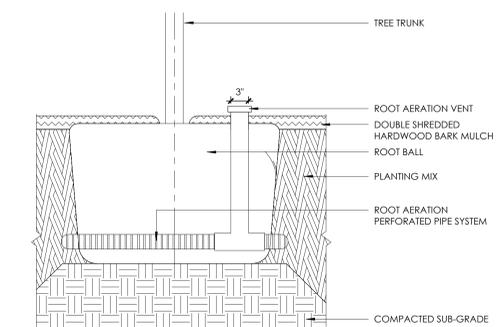

2 ROOT AERATION SYSTEM
1" = 1'-0"

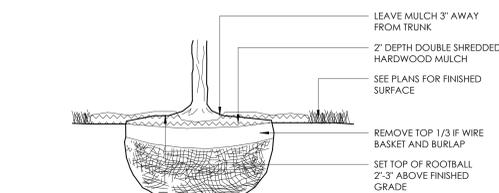

NOTES:
1. FINAL TREE LOCATIONS TO BE APPROVED BY OWNER AND LANDSCAPE ARCHITECT.
2. MARK THE NORTH SIDE OF THE TREE IN THE NURSERY AND ROTATE TREE TO FACE NORTH AT SITE WHEN POSSIBLE.
3. REMOVE EXCESS SOIL FROM ROOTBALL TO EXPOSE ROOT FLARE AND TRIM AND SECONDARY / ADVENTITIOUS, GIRDLING, AND POTENTIAL GIRDLING ROOTS WITH CLEAN, SHARP PRUNING TOOLS.
4. TREES IN LAWN AREAS, REMOVE EXISTING SOIL (10' X 10' X 3' DEPTH) AND REPLACE WITH PLANTING SOIL PRIOR TO PLANTING TREE. SCARIFY SUBGRADE PRIOR TO PLACING PLANTING SOIL.

1 TREE ROOTBALL PREPARATION
1" = 1'-0"

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PROVIDE CONTROL JT. IN ALL MASONRY WALLS @ A SPACING NOT TO EXCEED THE LESSOR OF 3 TIMES THE WALL HEIGHT OR 24 FEET O.C. IN ADDITION, PROVIDE CONTROL JT. @ THE FOLLOWING LOCATIONS:
 - CHANGES IN WALL HEIGHT
 - CHANGES IN WALL THICKNESS
 - WITHIN 24" OF WALL CORNERS AND INTERSECTIONS
 - TRANSITIONS FROM INTERIOR WALLS TO EXTERIOR WALLS
 - TRANSITIONS FROM WALLS BRG. ON FDN. TO WALLS BEARING ON FLOOR SLAB

PROVIDE AN 8" DP. BOND BM. COURSE W/ (2) #4 CONT. @ THE TOP OF ALL MASONRY WALLS IN ADDITION TO ALL OTHER BOND BM. NOTED OR DETAILED.


OPNG. WIDTH	CONTROL JOINTS
LESS THAN 2'-0"	NONE REQ'D.
2'-0" TO 6'-0"	ONE JAMB ONLY
WIDER THAN 6'-0"	BOTH JAMBS

PROVIDE TWO LAYERS OF 15-MIL PLASTIC VAPOR BARRIER BELOW ALL LINTEL BRG. (INCLUDING LOOSE ANGLE VENEER LINTELS) & CAULK FACE JT.

PROVIDE 24" LG. HORIZ. JT. REINF. FOR THREE COURSES BELOW LINTEL BRG. (INCLUDING VENEER)

SOLID BULLNOSE SILL BLOCK

PROVIDE ONE FULL-HEIGHT REINF. BAR @ EA. JAMB FOR EA. 6'-0" OF OPNG. WIDTH (SIZE TO MATCH TYP. WALL REINF.) WHERE CONTROL JT. IS SPECIFIED ABOVE, PLACE REINF. BAR A SUFFICIENT DISTANCE FROM JAMB AS TO BYPASS LINTEL BRG.

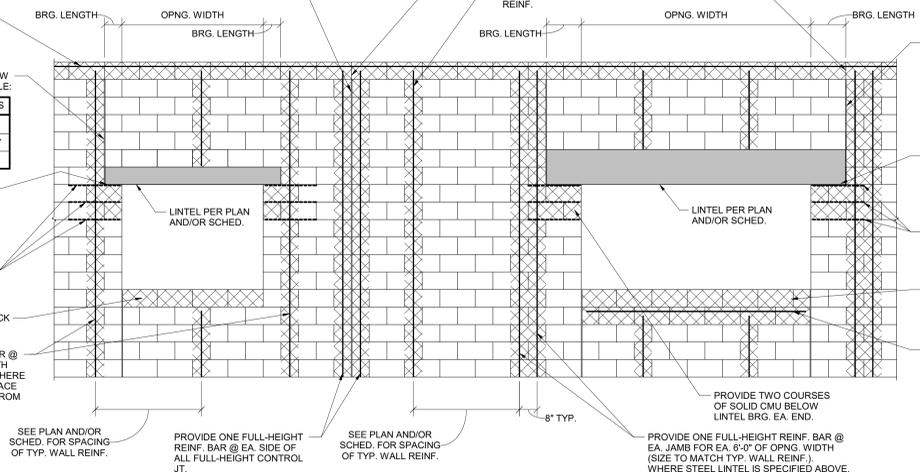

TYPICAL REINFORCED MASONRY WALL CONSTRUCTION

SECTION 1
3/8" = 1'-0"

OPNG. WIDTH	CONTROL JOINTS
LESS THAN 2'-0"	NONE REQ'D.
2'-0" TO 6'-0"	ONE JAMB ONLY
WIDER THAN 6'-0"	BOTH JAMBS

PROVIDE CONTROL JT. ABOVE & BELOW JAMBS PER THE FOLLOWING SCHEDULE:

PROVIDE TWO LAYERS OF 15-MIL PLASTIC VAPOR BARRIER BELOW ALL LINTEL BRG'S (INCLUDING LOOSE ANGLE VENEER LINTELS) & CAULK FACE JT.


PROVIDE 24" LG. HORIZ. JT. REINF. FOR THREE COURSES BELOW LINTEL BRG. (INCLUDING VENEER)

SOLID BULLNOSE SILL BLOCK

PROVIDE 8" DP. BOND BM. W/ (2) #4 CONT. IF OPNG. IS GREATER THAN 6'-0" WIDE.

PROVIDE TWO COURSES OF SOLID CMU BELOW LINTEL BRG. EA. END.


PROVIDE ONE FULL-HEIGHT REINF. BAR @ EA. JAMB FOR EA. 6'-0" OF OPNG. WIDTH (SIZE TO MATCH TYP. WALL REINF.) WHERE STEEL LINTEL IS SPECIFIED ABOVE, PLACE REINF. BAR A SUFFICIENT DISTANCE FROM JAMB AS TO BYPASS LINTEL BRG.

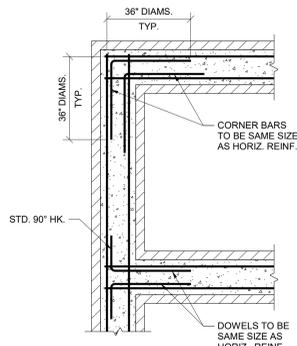

TYPICAL CORNER BARS FOR MASONRY BOND BEAMS

SECTION 2
3/4" = 1'-0"

MASONRY LINTELS

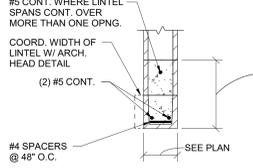

MARK	DEPTH (d)	MAX. SPAN (LND)
ML8	7 5/8"	6'-0"
ML16	1'-3 5/8"	8'-4"
ML24	1'-11 5/8"	10'-8"

- MASONRY LINTEL NOTES
- FILL IS 2500 PSI (MINIMUM) GROUT. USE FINE GROUT FOR WALLS 6 INCHES AND LESS.
 - FOR TYPE OF CMU AND TYPE OF BOND, SEE SPECIFICATION SECTION 042000.
 - LINTELS SHALL BEAR ON SOLID CMU OR ON 2 FILLED COURSES.
 - MAXIMUM SPANS DO NOT APPLY TO LOAD BEARING WALLS.
 - BOND PATTERN OF LINTEL TO MATCH THAT OF SURROUNDING WALL.
 - BOTTOM OF LINTEL SHALL BE SMOOTH MASONRY WITH NO CORES EXPOSED.
 - 14" LINTELS MAY BE MADE-UP OF TWO PIECES IF 14" BOND BEAM UNITS ARE NOT AVAILABLE.
 - PROVIDE 8" MINIMUM BEARING EACH END FOR 8" AND 16" DEEP LINTELS. USE 16" MINIMUM BEARING FOR 24" (AND DEEPER) LINTELS.
 - PROVIDE SCORED BLOCK AS REQUIRED TO MATCH ADJACENT WALL FINISH. REFER TO INTERIOR FINISH SCHEDULE FOR LOCATION OF ALL SCORED BLOCK.
 - PROVIDE TWO LAYERS OF 15-MIL PLASTIC VAPOR BARRIER BELOW ALL LINTEL BEARINGS AND CAULK FACE JOINT.


VENEER LINTELS

MARK	SIZE	MAX. SPAN (LND)
VL4	L4 x 4 x 5/16	6'-0"
VL6	L6 x 4 x 5/16 LLV	8'-4"

- VENEER LINTEL NOTES
- FURNISH AND INSTALL ALL LOOSE LINTELS REQUIRED FOR ALL OPENINGS IN MASONRY, INCLUDING MECHANICAL AND ELECTRICAL WORK, WHETHER SPECIFICALLY NOTED ON DRAWINGS OR NOT.
 - ALL LINTELS AT EXTERIOR LOCATIONS OR OTHERWISE SUBJECT TO WEATHER OR CORROSIVE ATMOSPHERE SHALL BE GALVANIZED.
 - PROVIDE 6" MINIMUM BEARING EACH END.
 - PROVIDE TWO LAYERS OF 15-MIL PLASTIC VAPOR BARRIER BELOW ALL LINTEL BEARINGS AND CAULK FACE JOINT.

SECTION 3
3/4" = 1'-0"

SECTION 4
3/4" = 1'-0"

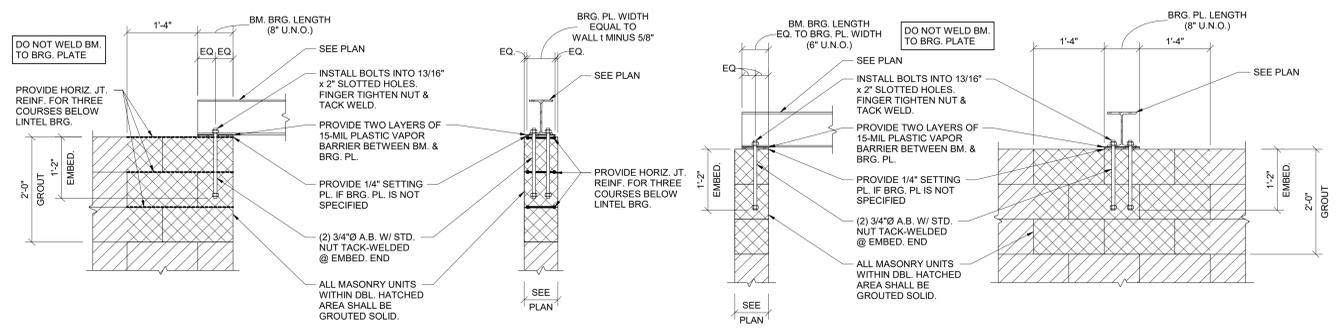

TYPICAL BEAM BEARING PARALLEL TO MASONRY WALL OR AT CORNER OF MASONRY WALL

SECTION 5
3/4" = 1'-0"

TYPICAL BEAM BEARING PERPENDICULAR TO MASONRY WALL

SECTION 6
3/4" = 1'-0"


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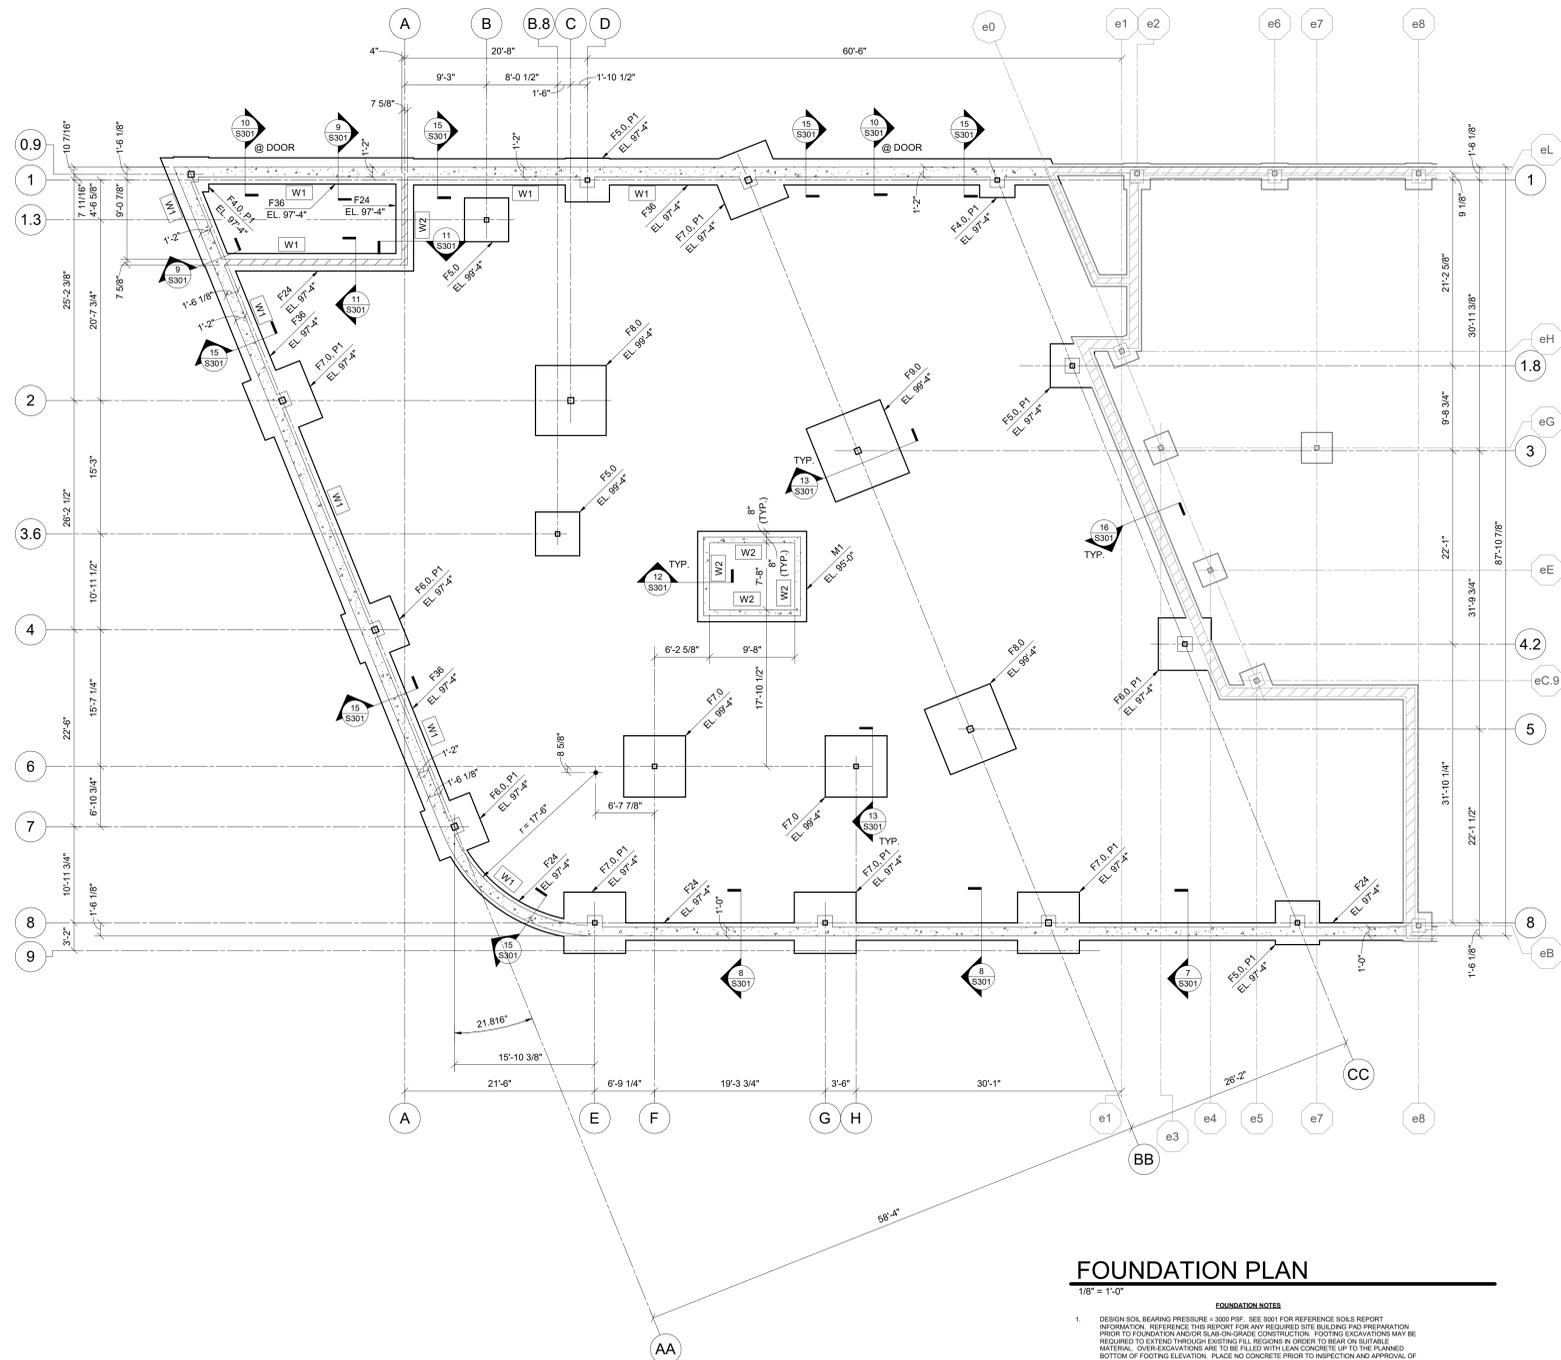
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 2223 CLEVELAND AVE
 COLUMBUS, OH 43211
 FOR
COLUMBUS METROPOLITAN LIBRARY

MOODY-NOLAN
 300 SPRUCE STREET
 SUITE 300
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 PHONE: (614) 461-4664
 FAX: (614) 280-8881

DRAWING TITLE:
GENERAL STRUCTURE INFORMATION

NOVEMBER 21, 2023
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S002
 CONSTRUCTION DOCUMENTS



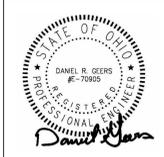


FOUNDATION PLAN

1/8" = 1'-0"

FOUNDATION NOTES

- DESIGN SOIL BEARING CAPACITY = 3000 PSF. SEE S01 FOR REFERENCE SOILS REPORT INFORMATION. REFER TO THIS REPORT FOR ANY REQUIRED SITE BUILDING AND PREPARATION PRIOR TO FOUNDATION AND/OR REBAR/SHIELD CONSTRUCTION. FOOTING ELEVATIONS MAY BE REQUIRED TO EXTEND THROUGH EXISTING FILL REGIONS IN ORDER TO BEAR ON SUITABLE MATERIAL. OVERLAP INDICATORS ARE TO BE FILLED WITH LEAN CONCRETE UP TO THE FINISHED BOTTOM OF FOOTING ELEVATION. PLACE NO CONCRETE PRIOR TO INSPECTION AND APPROVAL OF BEARING SURFACES BY SOILS ENGINEER.
- KEEP FOUNDATIONS FREE OF WATER AT ALL TIMES. REPLACE WEAKENED SOIL WITH LEAN CONCRETE OR FLOWABLE FILL.
- BOTTOM OF FOOTINGS ARE TO BE AT LEAST 36-INCHES BELOW THE ADJACENT EXTERIOR FINISHED GRADE FOR PROTECTION.
- ELEVATIONS SHOWN ON FOOTINGS INDICATE ELEVATION AT TOP OF FOOTING. REFERENCE ELEVATION TOP OF CONCRETE SLAB ELEVATION AS NOTED ON PLANS. COORDINATE ABSOLUTE ELEVATION OF TOP OF SLAB WITH SITE DRAWINGS.
- INDICATES FOOTING STEP PER SECTION S3031. STEP AT A RATIO NOT TO EXCEED ONE VERTICAL TO TWO HORIZONTAL.
- INDICATES APPROXIMATE LOCATION AND INVERT DEPTH OF UNDERGROUND UTILITIES. COORDINATE THE LOCATION AND DEPTH OF ALL UNDERGROUND MECHANICAL, ELECTRICAL, PLUMBING, AND/OR CIVIL WORK PRIOR TO CONSTRUCTION. NOT ALL UNDERGROUND UTILITIES ARE SHOWN ON THE STRUCTURAL DRAWINGS. FOUNDATIONS BUILT PRIOR TO THE INSTALLATION OF UNDERGROUND UTILITIES ARE TO BE STEPPED OR DROPPED COMPLETELY BELOW THE UTILITY DEPTH PER SECTION S3031. WHERE UNDERGROUND UTILITIES ARE IN PLACE PRIOR TO FOUNDATION CONSTRUCTION, THEY ARE TO BE ENCASED PER SECTION S3031. SEE SECTION S3031 FOR TRENCH EXCAVATION AND UTILITY PLACEMENT REQUIREMENTS FOR WORK THAT IS ADJACENT TO FOOTINGS.
- SEE ELEVATION ON S301 FOR TYPICAL REINFORCED MASONRY WALL CONSTRUCTION.
- PROVIDE CORNER BARS AT ALL FOOTING AND CONCRETE WALL INTERSECTIONS PER DETAIL S3031.
- SEE SHEET S201 FOR COLUMN SCHEDULE.
- SEE SHEET S201 FOR GENERAL STRUCTURAL INFORMATION.

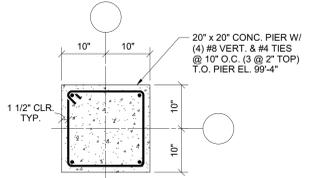

PIER P1

MAT FOOTING SCHEDULE		
MARK	THICKNESS	REINFORCING
M1	1'-4"	#5 @ 12" O.C. E.W. T&B

CONT. WALL FOOTING SCHEDULE		
MARK	SIZE	REINFORCING
F24	2'-0" x 1'-0" DP.	(2) #5 CONT.
F36	3'-0" x 1'-0" DP.	(3) #5 CONT.

SPREAD FOOTING SCHEDULE		
MARK	SIZE	REINFORCING
F4.0	4'-0" x 4'-0" x 1'-0" DP.	(4) #5 E.W.
F5.0	5'-0" x 5'-0" x 1'-0" DP.	(5) #5 E.W.
F6.0	6'-0" x 6'-0" x 1'-0" DP.	(6) #6 E.W.
F7.0	7'-0" x 7'-0" x 1'-0" DP.	(7) #6 E.W.
F8.0	8'-0" x 8'-0" x 1'-6" DP.	(8) #6 E.W.
F9.0	9'-0" x 9'-0" x 1'-9" DP.	(9) #7 E.W.

WALL REINFORCING SCHEDULE	
MARK	SIZE
W1	#5 @ 32" O.C.
W2	#5 @ 24" O.C.


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FOUNDATION PLAN

NOVEMBER 21, 2023
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 Proj. # 21507
S101
 CONSTRUCTION DOCUMENTS



SLAB ON GRADE PLAN


1/8" = 1'-0"
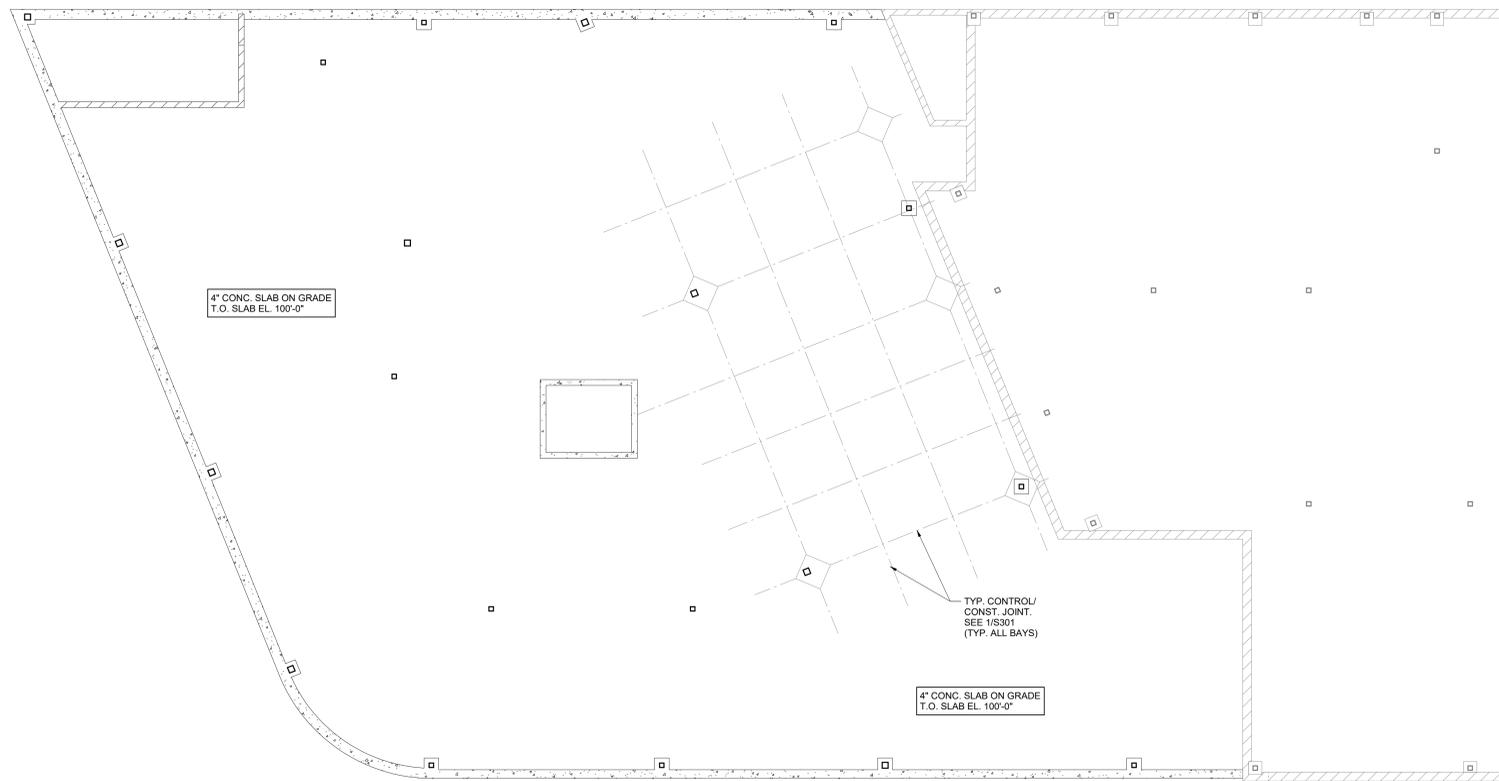
#	DATE	CHANGE DESCRIPTION


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SLAB ON GRADE PLAN



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ROOF FRAMING PLAN

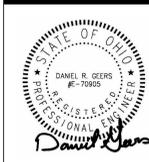1/8" = 1'-0"

ROOF FRAMING NOTES

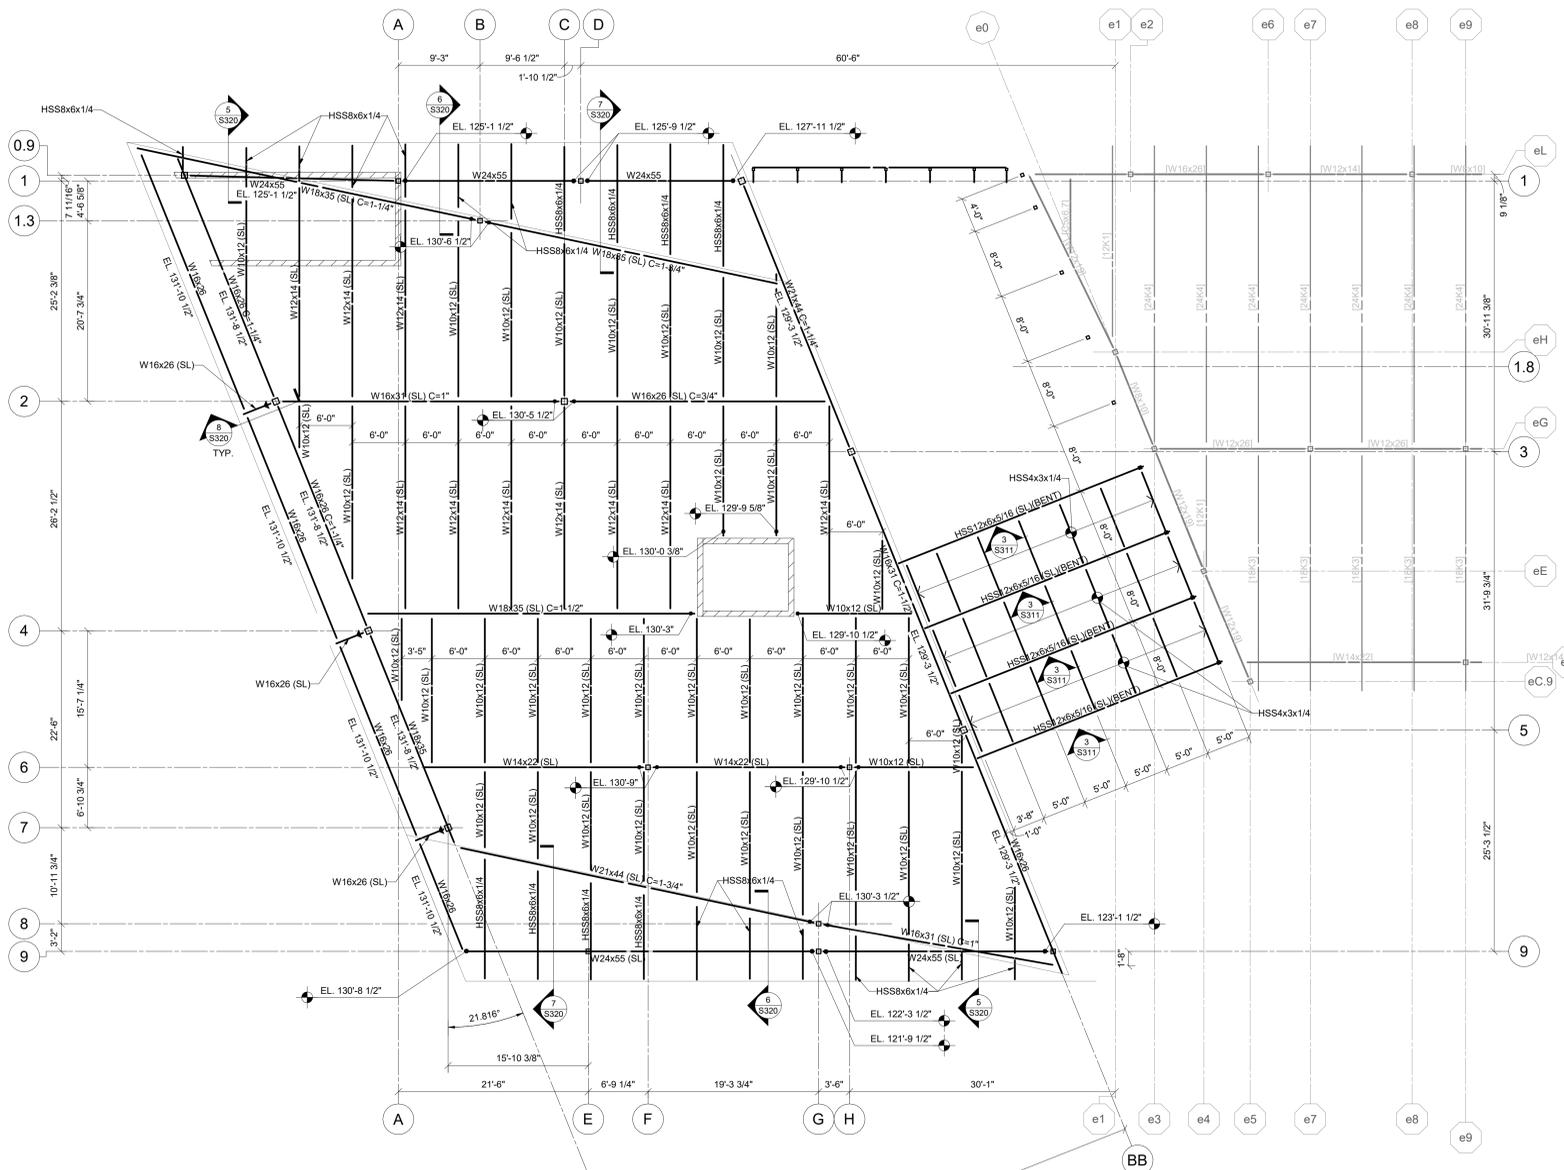- DESIGN LIVE LOADS:
FLAT ROOF SNOW: 20 PSF - CRFT
WIND (ADD NET UPLIFT): 15 PSF
COLLATERAL: 8 PSF
MECHANICAL LIVE: AS SHOWN
- ROOF CONSTRUCTION:
1-1/2" x 20 GA WIDE RIB METAL DECK. SEE SECTION 15320 FOR TYPICAL ATTACHMENT TO SUPPORTING STRUCTURE.
3" x 20 GA WIDE RIB METAL DECK. SEE SECTION 15320 FOR TYPICAL ATTACHMENT TO SUPPORTING STRUCTURE.
- TOP OF STEEL ELEVATION - AS NOTED ON PLAN. REFERENCE ELEVATION 130'-0" = TOP OF FIRST FLOOR SLAB ON GRADE.
- SEE SECTIONS ON S310 FOR TYPICAL STEEL FRAMING DETAILS.
- ALL JOISTS ARE TO BE DESIGNED FOR NET UPLIFT AS DEFINED IN DESIGN LOADS ABOVE. PROVIDE BRIDGING IN ADDITION TO MINIMUM SJI REQUIREMENTS IF NEEDED.
- CAMBER IS NOT REQUIRED IN STEEL BEAMS UNLESS INDICATED BY "C".
- INDICATES SNOW DRIFT ROOF LOADINGS. JOISTS HAVE BEEN SIZED FOR THE LOAD SHOWN UNLESS NOTED OR SCHEDULED OTHERWISE. WOOD TRUSSES ARE TO BE DESIGNED TO ACCOMMODATE ADDITIONAL LOADINGS. PRE-ENGINEERED METAL BUILDING STRUCTURE IS TO BE DESIGNED TO ACCOMMODATE ADDITIONAL LOADINGS.
- INDICATES ROOF OPENING. DETERMINE EXACT SIZE AND LOCATION FROM ARCHITECTURAL AND MECHANICAL DRAWINGS. NOT ALL OPENINGS ARE SHOWN ON THE STRUCTURAL DRAWINGS. SEE SECTION 23200 FOR FRAMING OF ALL OPENINGS EQUAL TO OR GREATER THAN 12" SQUARE OR DIAMETER. SIZE OF OPENING IS NOT TO EXCEED THE TYPICAL CLEAR SPACES BETWEEN FRAMING MEMBERS. NOTIFY THE ARCHITECT BEFORE PROCEEDING IF OPENINGS CANNOT BE FIT BETWEEN FRAMING MEMBERS.
- INDICATES MECHANICAL LOAD SUPPORTED ON ROOF. COORDINATE FINAL SIZE, WEIGHT, LOCATION, AND OPENING REQUIREMENTS WITH MECHANICAL CONTRACTOR. TOLERANCE FOR LOCATION OF ACTUAL UNIT IS 3 FEET IN ANY DIRECTION FROM WHERE SHOWN ON THE STRUCTURAL DRAWINGS. PROVIDE SUPPORT FRAME PER SECTION 45320 AND REINFORCE JOISTS AT SUPPORT LOCATIONS PER SECTION 45320.
- 15k INDICATES UNFACTORED (ASD) STEEL BEAM REACTION IN KIPS TO BE USED IN CONNECTION DESIGN. SEE GENERAL STRUCTURAL NOTES/SPECS FOR MORE INFORMATION.
- INDICATES MASONRY BEARING LENGTH IN INCHES OR BEARING PLATE TYPE PER SCHEDULE. WHERE NO BEARING PLATE IS SPECIFICALLY INDICATED, PROVIDE 14" SETTING PLATE AND 3/4" ANCHOR BOLTS AS SHOWN IN SECTIONS 75320 AND 85320.
- INDICATES MASONRY UNITS FOR WALL OPENINGS. SEE ARCHITECTURAL DRAWINGS FOR CHORDING DIMENSIONS AND SHEET 2001 FOR MASONRY UNITS, TYPES AND SCHEDULE.
- SEE SHEET S201 FOR COLUMN SCHEDULE.
- SEE ARCHITECTURAL DRAWINGS FOR ANY DIMENSIONS NOT INDICATED HEREIN.
- SEE SHEET 9001 FOR GENERAL STRUCTURAL INFORMATION.

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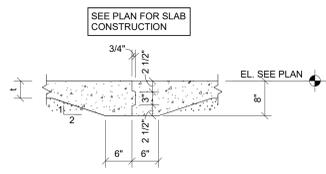
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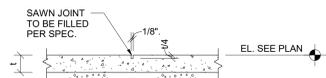
ROOF FRAMING PLAN

NOVEMBER 21, 2023
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 Proj. # 21507
S103
 CONSTRUCTION DOCUMENTS







TYPICAL FLOOR CONSTRUCTION JOINT




TYPICAL FLOOR CONTROL JOINT

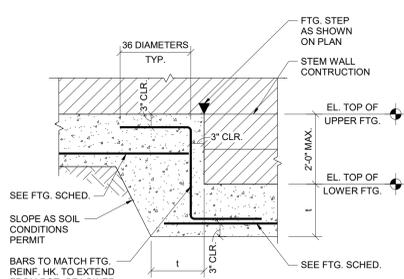


TYPICAL FOOTING STEP

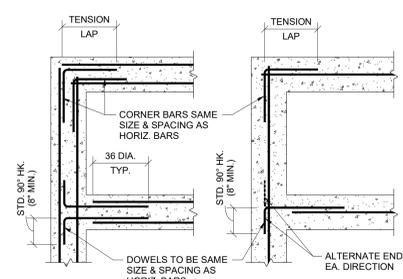


TYPICAL CORNER BARS FOR CONCRETE WALL AND FOOTING CONSTRUCTION

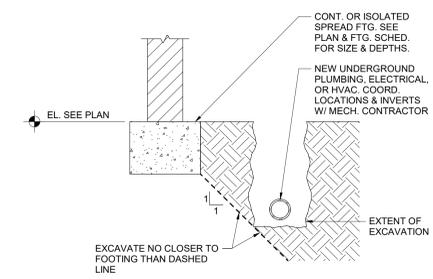

TYPICAL EXCAVATION CLEARANCE REQUIREMENTS AT NEW UNDERGROUND WORK

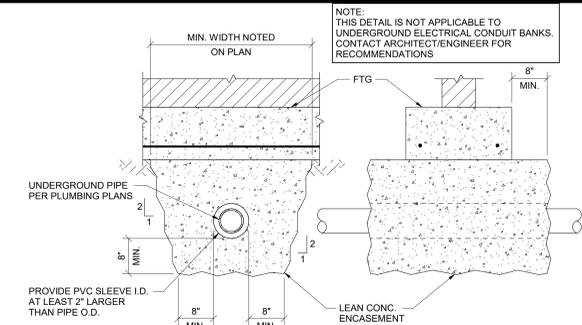

TYPICAL PIPE BELOW FOOTING

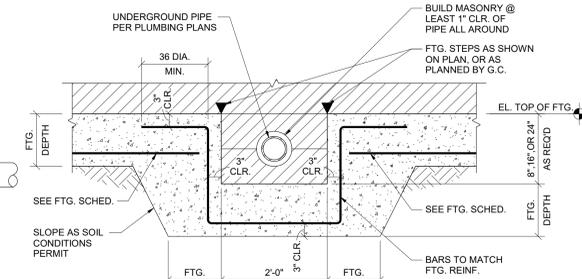

TYPICAL STEPPED FOOTING FOR UNDERGROUND PLUMBING

SECTION 1 3/4" = 1'-0"





SECTION 2 3/4" = 1'-0"

SECTION 3 3/4" = 1'-0"



SECTION 4 3/4" = 1'-0"

SECTION 5 3/4" = 1'-0"

SECTION 6 3/4" = 1'-0"

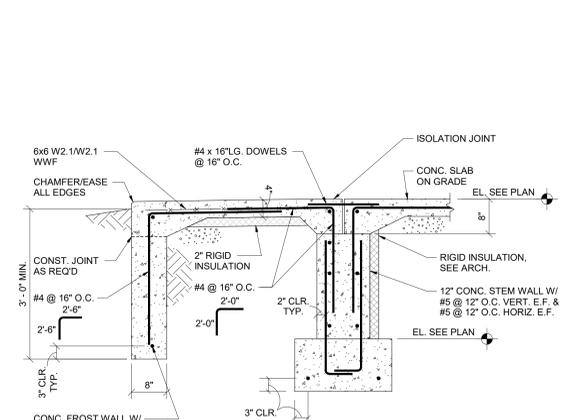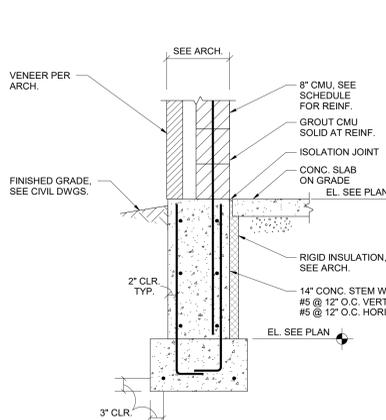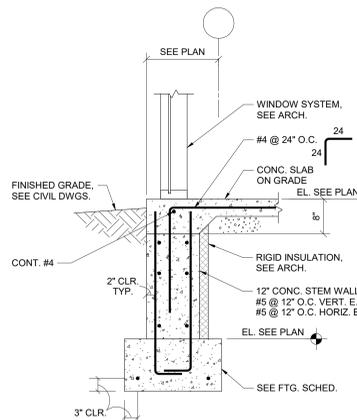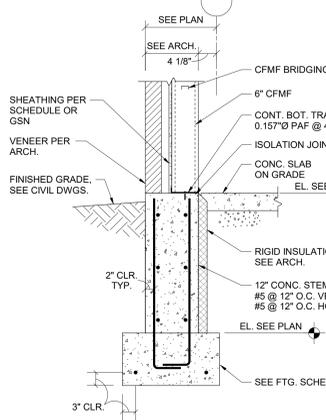

TYPICAL MAN DOOR TRANSITION

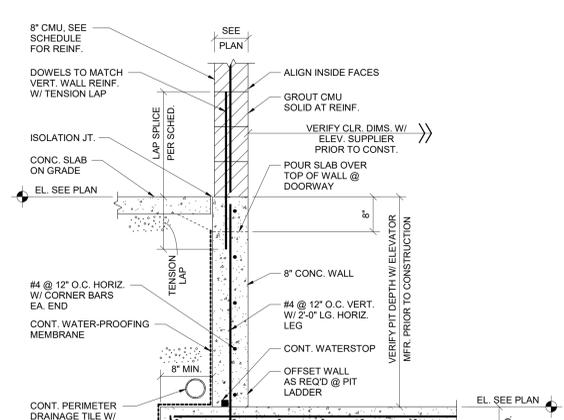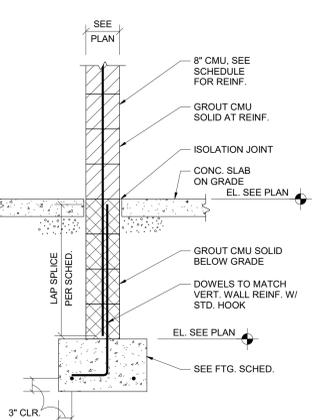

THICKEN MAT AS REQ'D @ SUMP & PROVIDE ADDL #4 BENT BARS @ 12\"/>

SECTION 7 3/4" = 1'-0"


SECTION 8 3/4" = 1'-0"

SECTION 9 3/4" = 1'-0"


SECTION 10 3/4" = 1'-0"

SECTION 11 3/4" = 1'-0"


SECTION 12 3/4" = 1'-0"

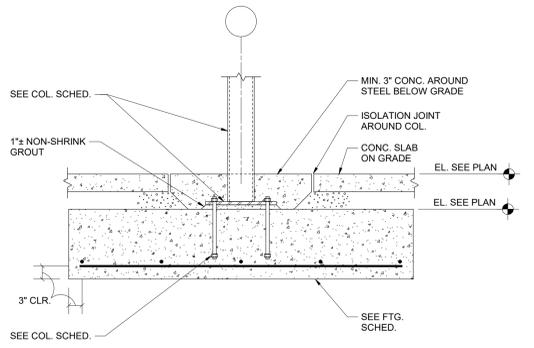


SECTION 13 3/4" = 1'-0"

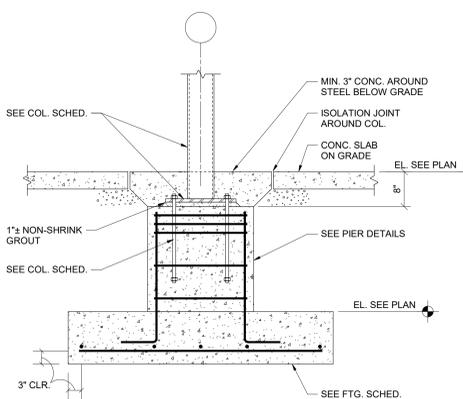


SECTION 14 3/4" = 1'-0"

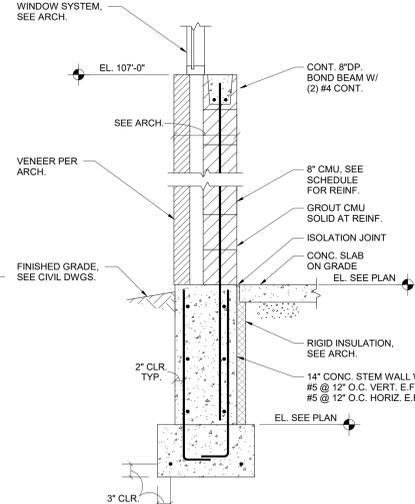

SECTION 15 3/4" = 1'-0"

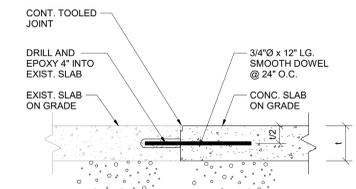

TYPICAL NEW-TO-EXISTING SLAB TRANSITION

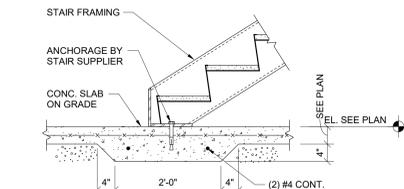

TYPICAL THICKENED SLAB AT BASE OF STAIR STRINGER

SECTION 16 1 1/2" = 1'-0"

SECTION 17 3/4" = 1'-0"

#	DATE	CHANGE DESCRIPTION


CML LINDEN BRANCH
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 COLUMBUS, OH 43211
 FOR
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 300 SPRUCE STREET
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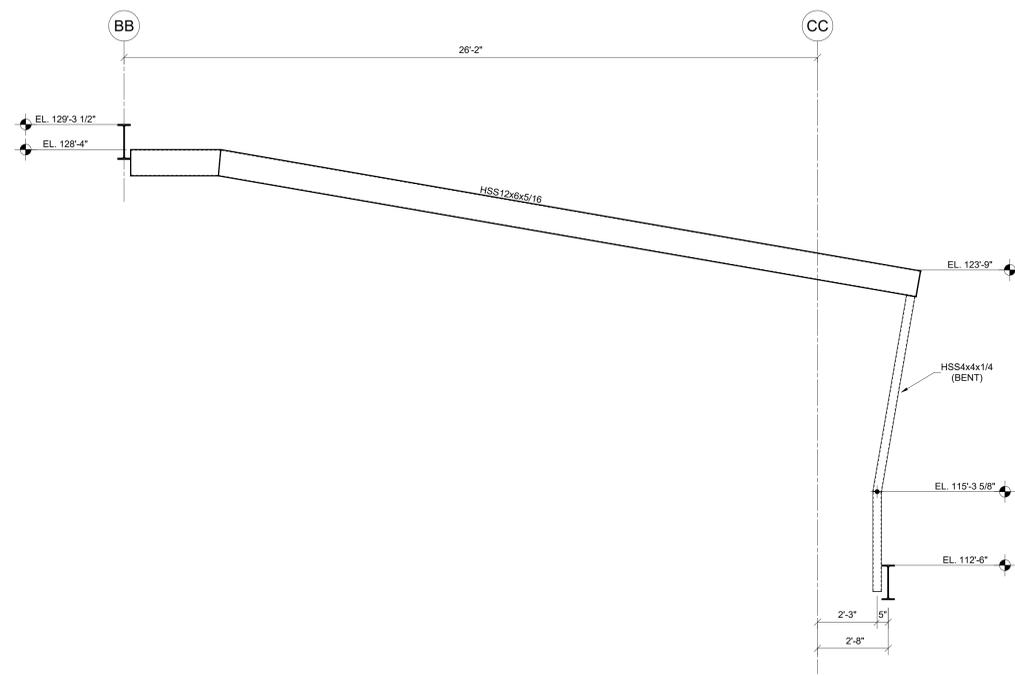
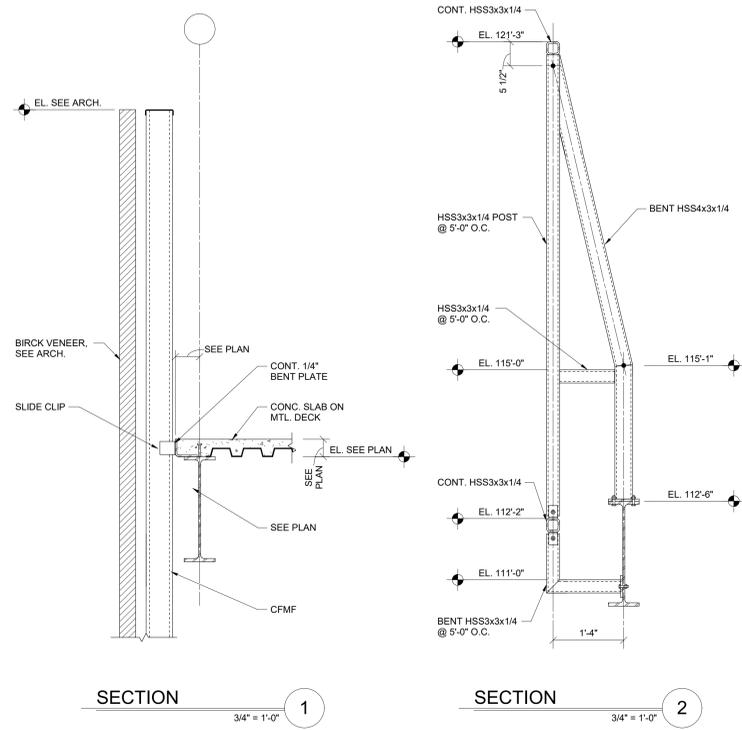
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FRAMING DETAILS



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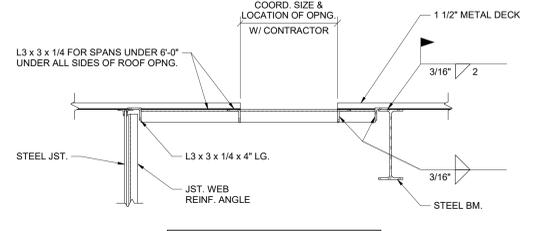
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S311


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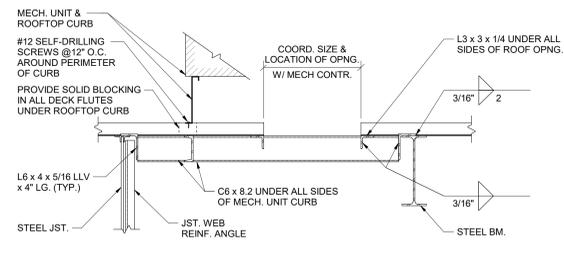
SECTION 1
3/4" = 1'-0"




TYPICAL ROOF OPENING FRAMING
SECTION 2
3/4" = 1'-0"

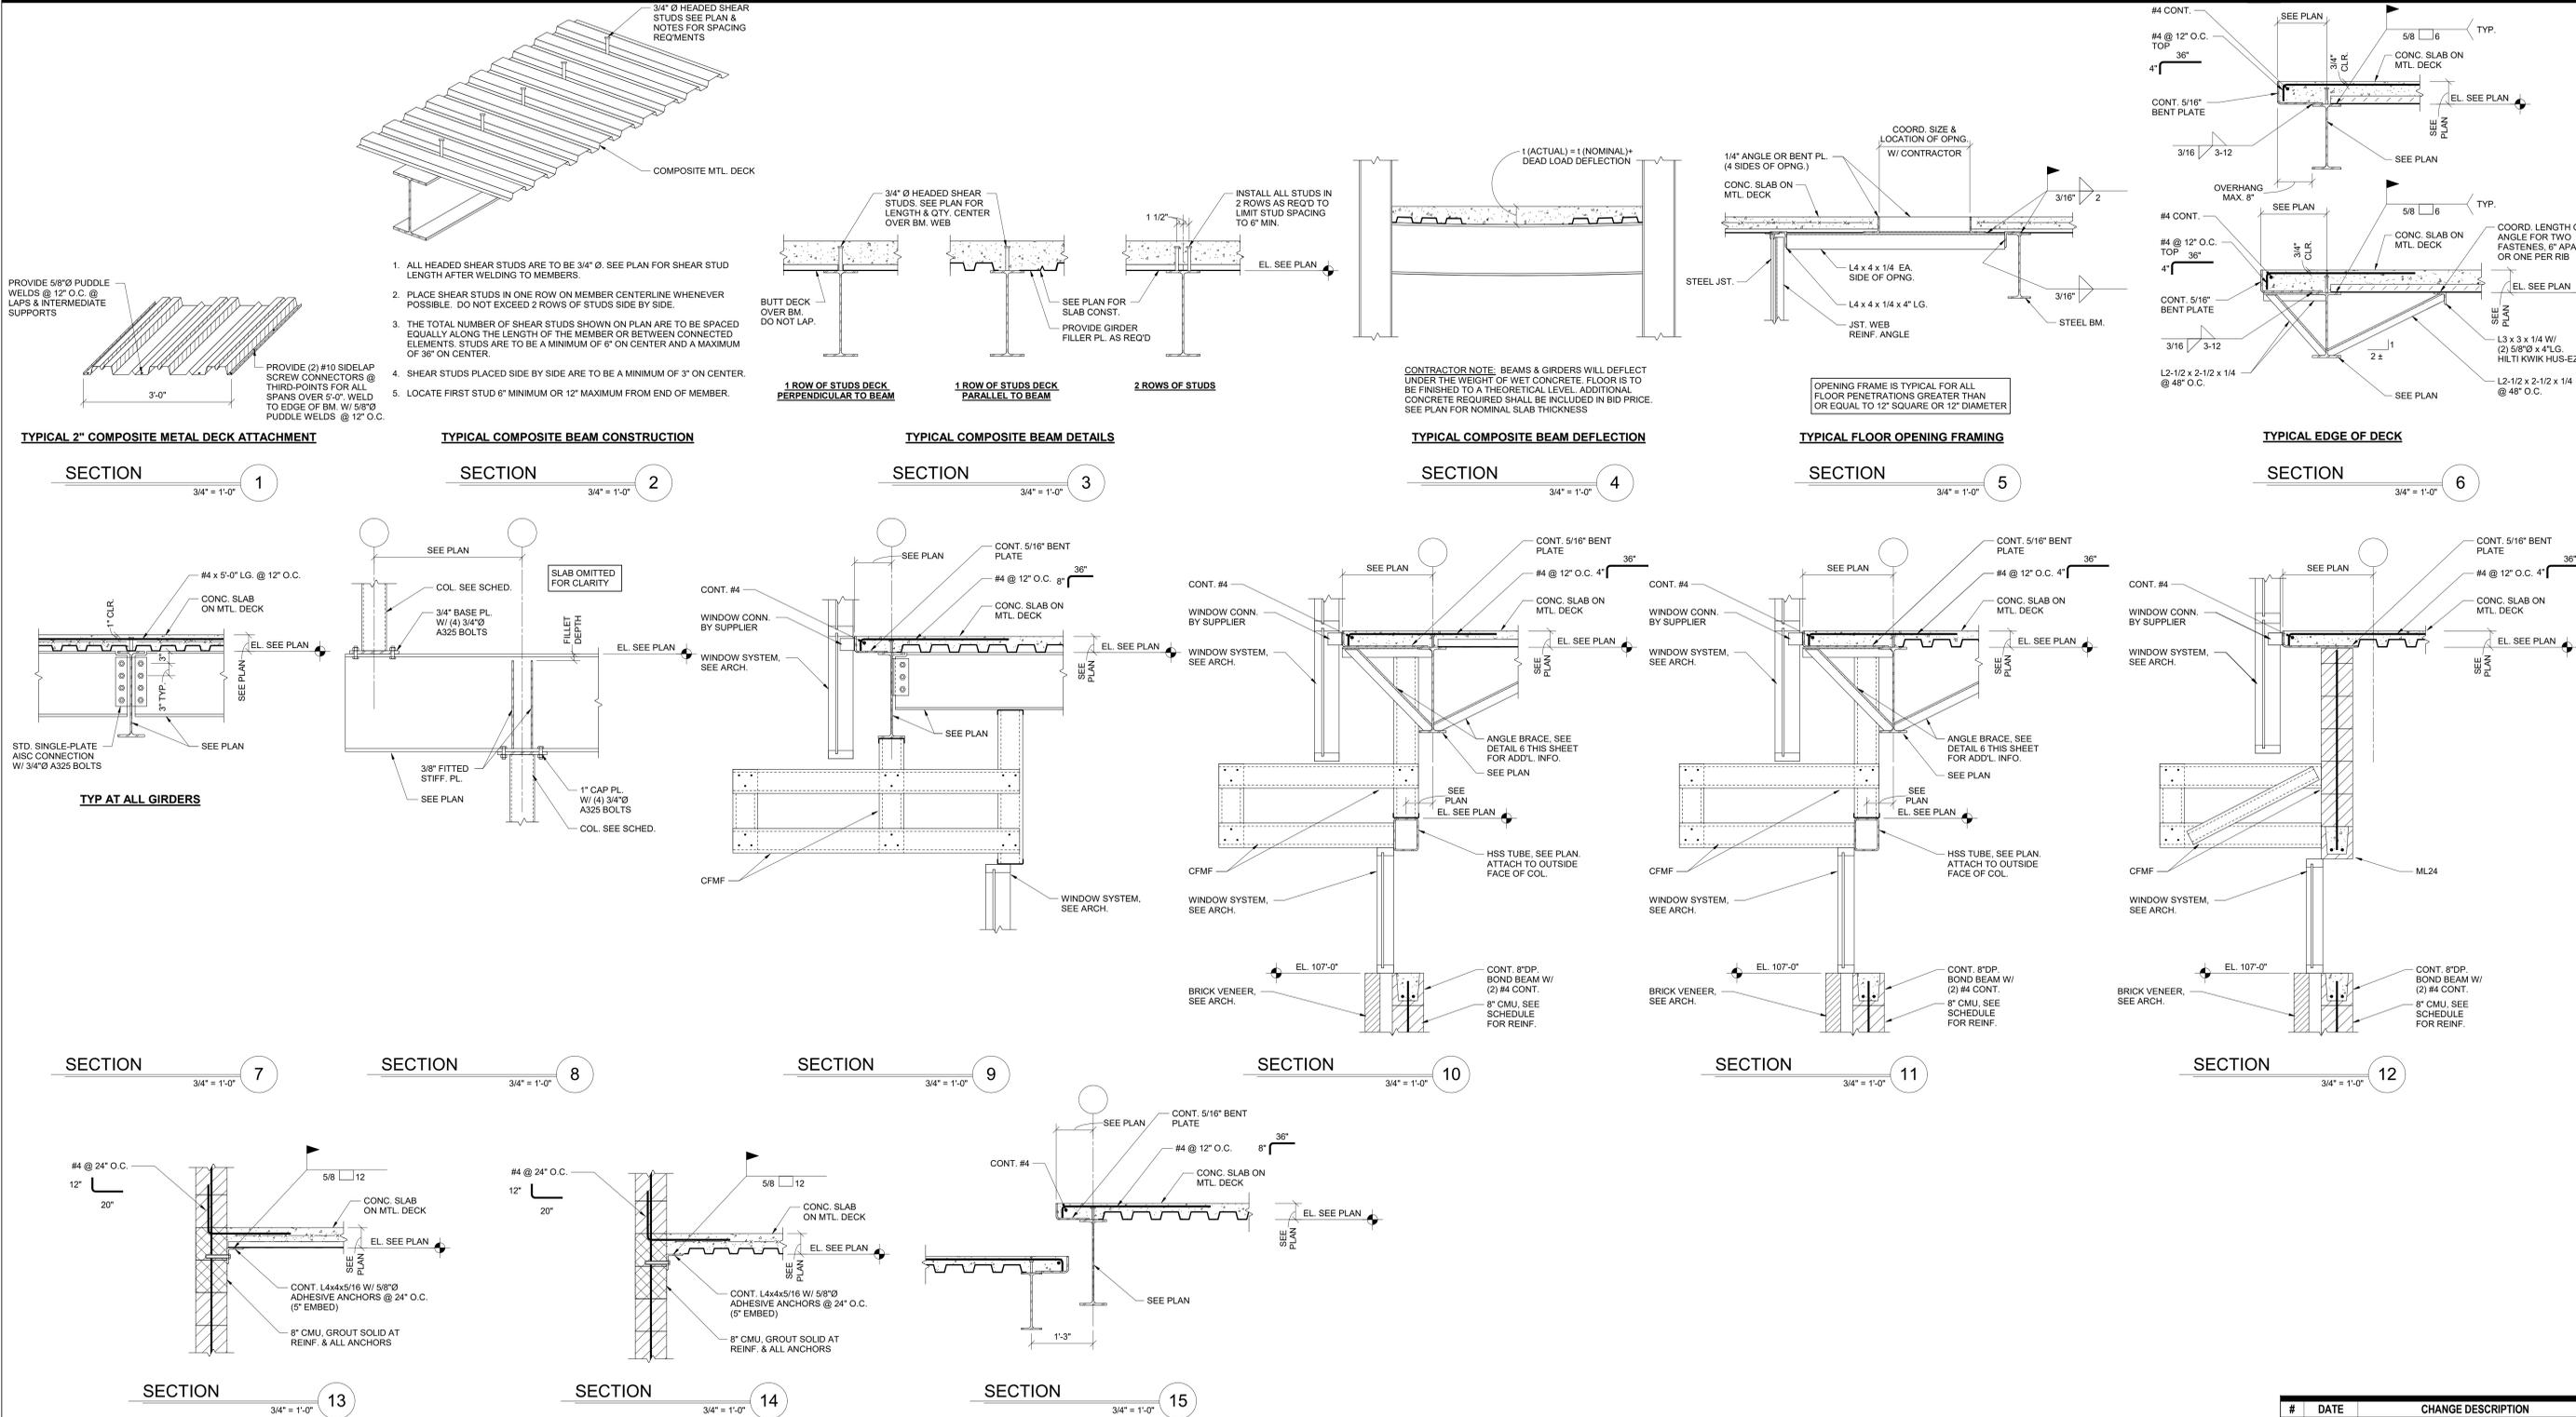

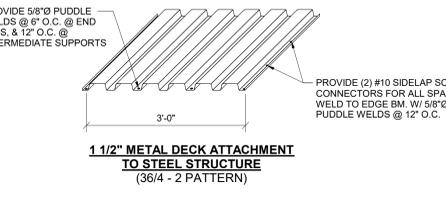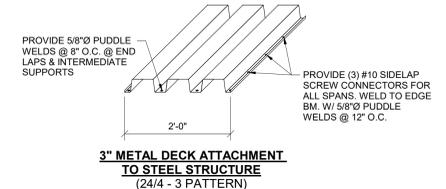
TYPICAL MECHANICAL UNIT SUPPORT AND ROOF OPENING FRAMING
SECTION 3
3/4" = 1'-0"

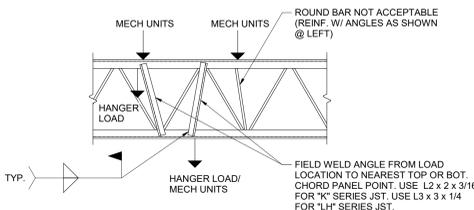


TYPICAL MECHANICAL UNIT SUPPORT AND ROOF OPENING FRAMING
SECTION 4
3/4" = 1'-0"

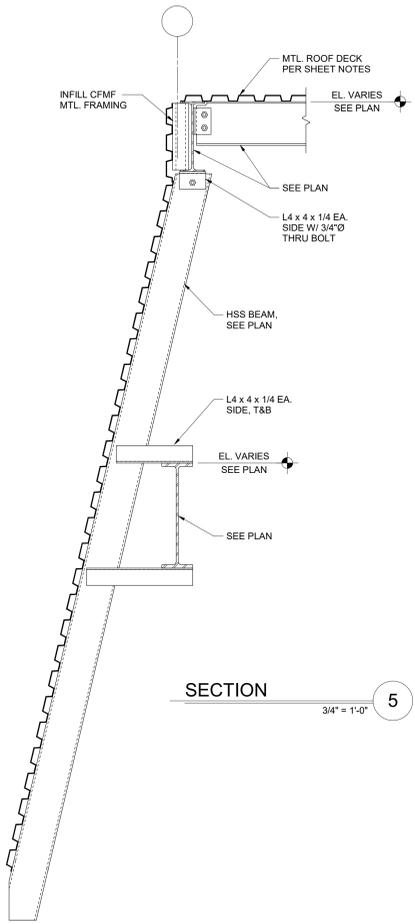


SECTION 5
3/4" = 1'-0"

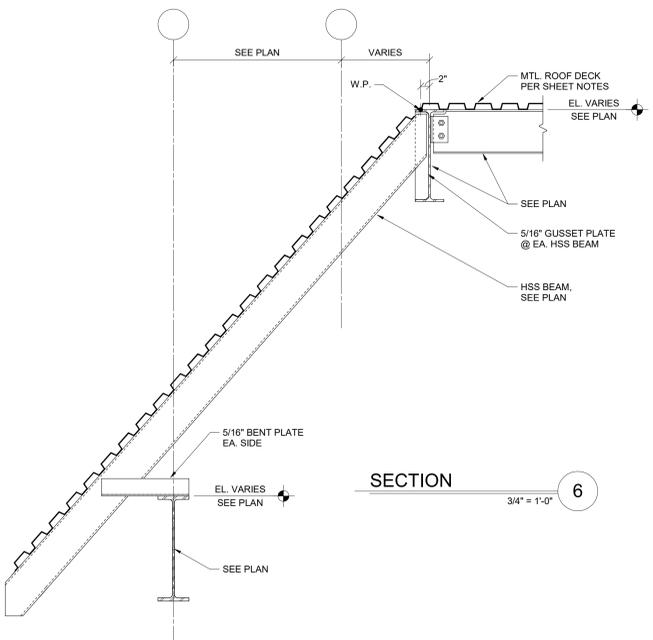

SECTION 6
3/4" = 1'-0"

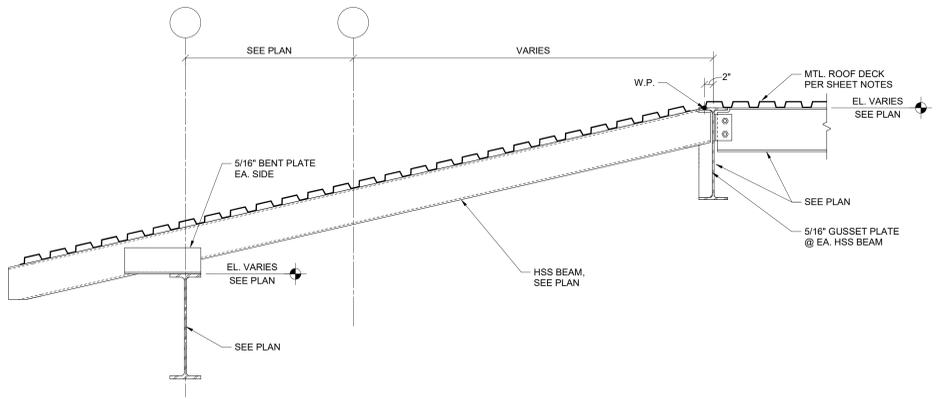

SECTION 7
3/4" = 1'-0"

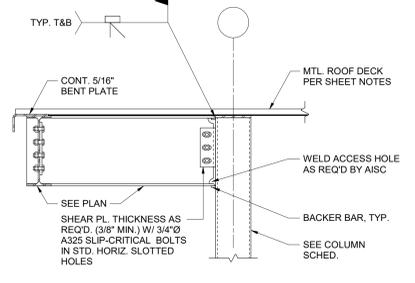

SECTION 8
3/4" = 1'-0"

#	DATE	CHANGE DESCRIPTION


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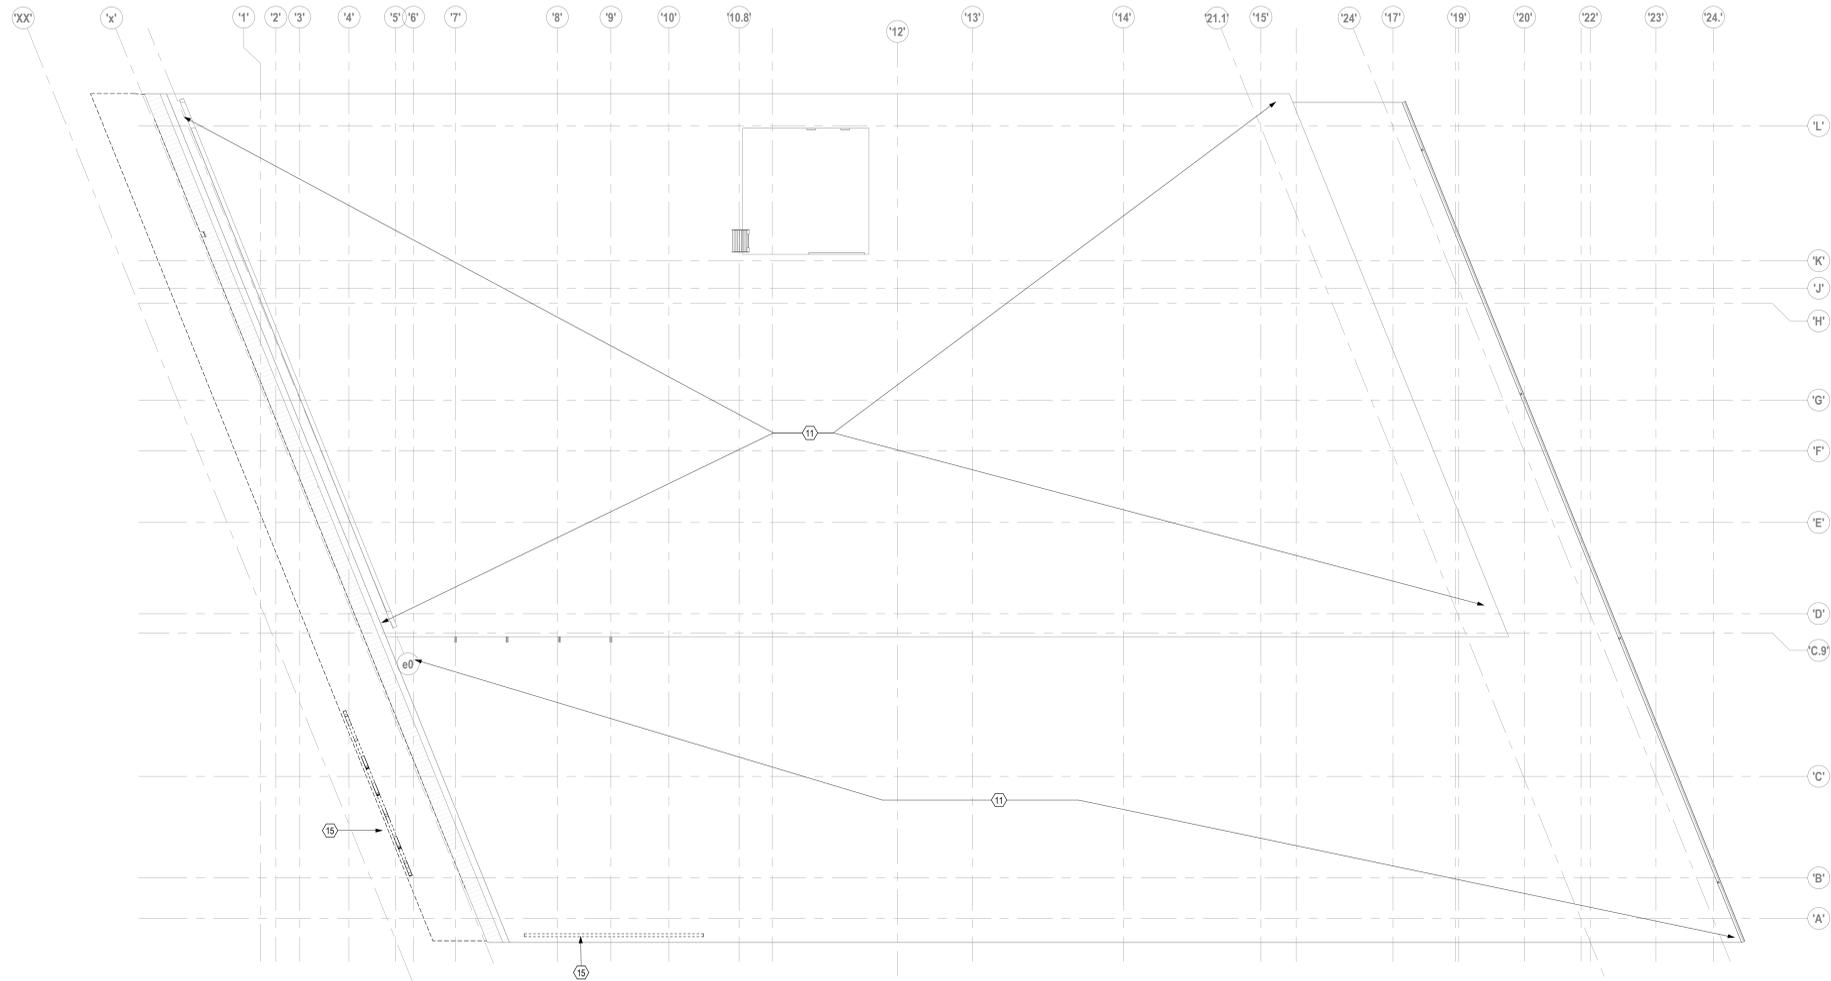
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Proj. # 21507
S320
CONSTRUCTION DOCUMENTS




1 PLAN OVERALL FIRST FLOOR DEMOLITION PLAN
1/8" = 1'-0"



CODED NOTES - DEMOLITION PLANS		GENERAL NOTES - DEMOLITION PLANS		#	DATE	CHANGE DESCRIPTION
1.	EXISTING PARTITION TO REMAIN. PREPARE AS REQUIRED FOR NEW CONSTRUCTION	KEY VALUE	KEYNOTE TEXT			
2.	EXISTING STAIRS TO REMAIN. PROTECT AND REPAIR DURING CONSTRUCTION	1.	X			
3.	EXISTING DOWNSPOUT, TO BE RELOCATED. PROVIDE PROTECTION DURING CONSTRUCTION					
4.	EXISTING COLUMN TO REMAIN. PROVIDE PROTECTION DURING CONSTRUCTION					
5.	EXISTING BOOK DROP TO BE REMOVED. INFILL TO MATCH EXISTING FACADE					
6.	EXISTING RAMP TO REMAIN AND BE PROTECTED DURING CONSTRUCTION					
7.	EXISTING PLASTER. REMOVE AND PREPARE SITE AS REQUIRED FOR NEW CONSTRUCTION					
8.	REMOVE AND DISPOSE OF EXISTING CASEWORK					
9.	REMOVE AND DISPOSE OF EXISTING PLUMBING FIXTURES					
10.	REMOVE AND DISPOSE OF EXISTING ROOF TOP MEP AS REQUIRED PER MEP DRAWINGS					
11.	REMOVE EXISTING ROOF. ROOF MEMBRANE & INSULATION CLEAN & REPAIR ROOF DECKING AS REQUIRED TO RECEIVE NEW ROOF INSULATION & MEMBRANE					
12.	REMOVE CHANNEL SUNSCREEN WHERE POSSIBLE					
13.	EXISTING STOREFRONT TO BE REMOVED AND REPLACED WITH STOREFRONT AND GLASS TO MATCH NEW CONSTRUCTION					
14.	REMOVE EXISTING STOREFRONT AND DOOR SYSTEM					
15.	EXISTING LIBRARY SIGNAGE ON THE CANOPY TO BE SALVAGED AND REUSED					
DEMOLITION LEGEND						
	ROOM NUMBER					
	CONSTRUCTION TO REMAIN					
	CONSTRUCTION TO BE REMOVED					
	DOOR TO REMAIN					
	DOOR TO BE REMOVED					
<p>CML LINDEN BRANCH 2223 CLEVELAND AVE COLUMBUS, OH 43211 FOR COLUMBUS METROPOLITAN LIBRARY</p> <p>300 SPRUCE STREET SUITE 300 COLUMBUS, OHIO 43215 PHONE: (614) 461-4664 FAX: (614) 280-8881</p> <p>MOODY-NOLAN</p> <p>DRAWING TITLE: LEVEL 01 - DEMOLITION PLAN</p> <p>NOVEMBER 21, 2023 DRAWN BY: XXXX CHECKED BY: XXXX Proj. # 21507.02 AD101 PERMIT SET</p> <p>JONATHAN D. MOODY, LIC. #1215709 EXP. DATE: 12/31/2023</p>						

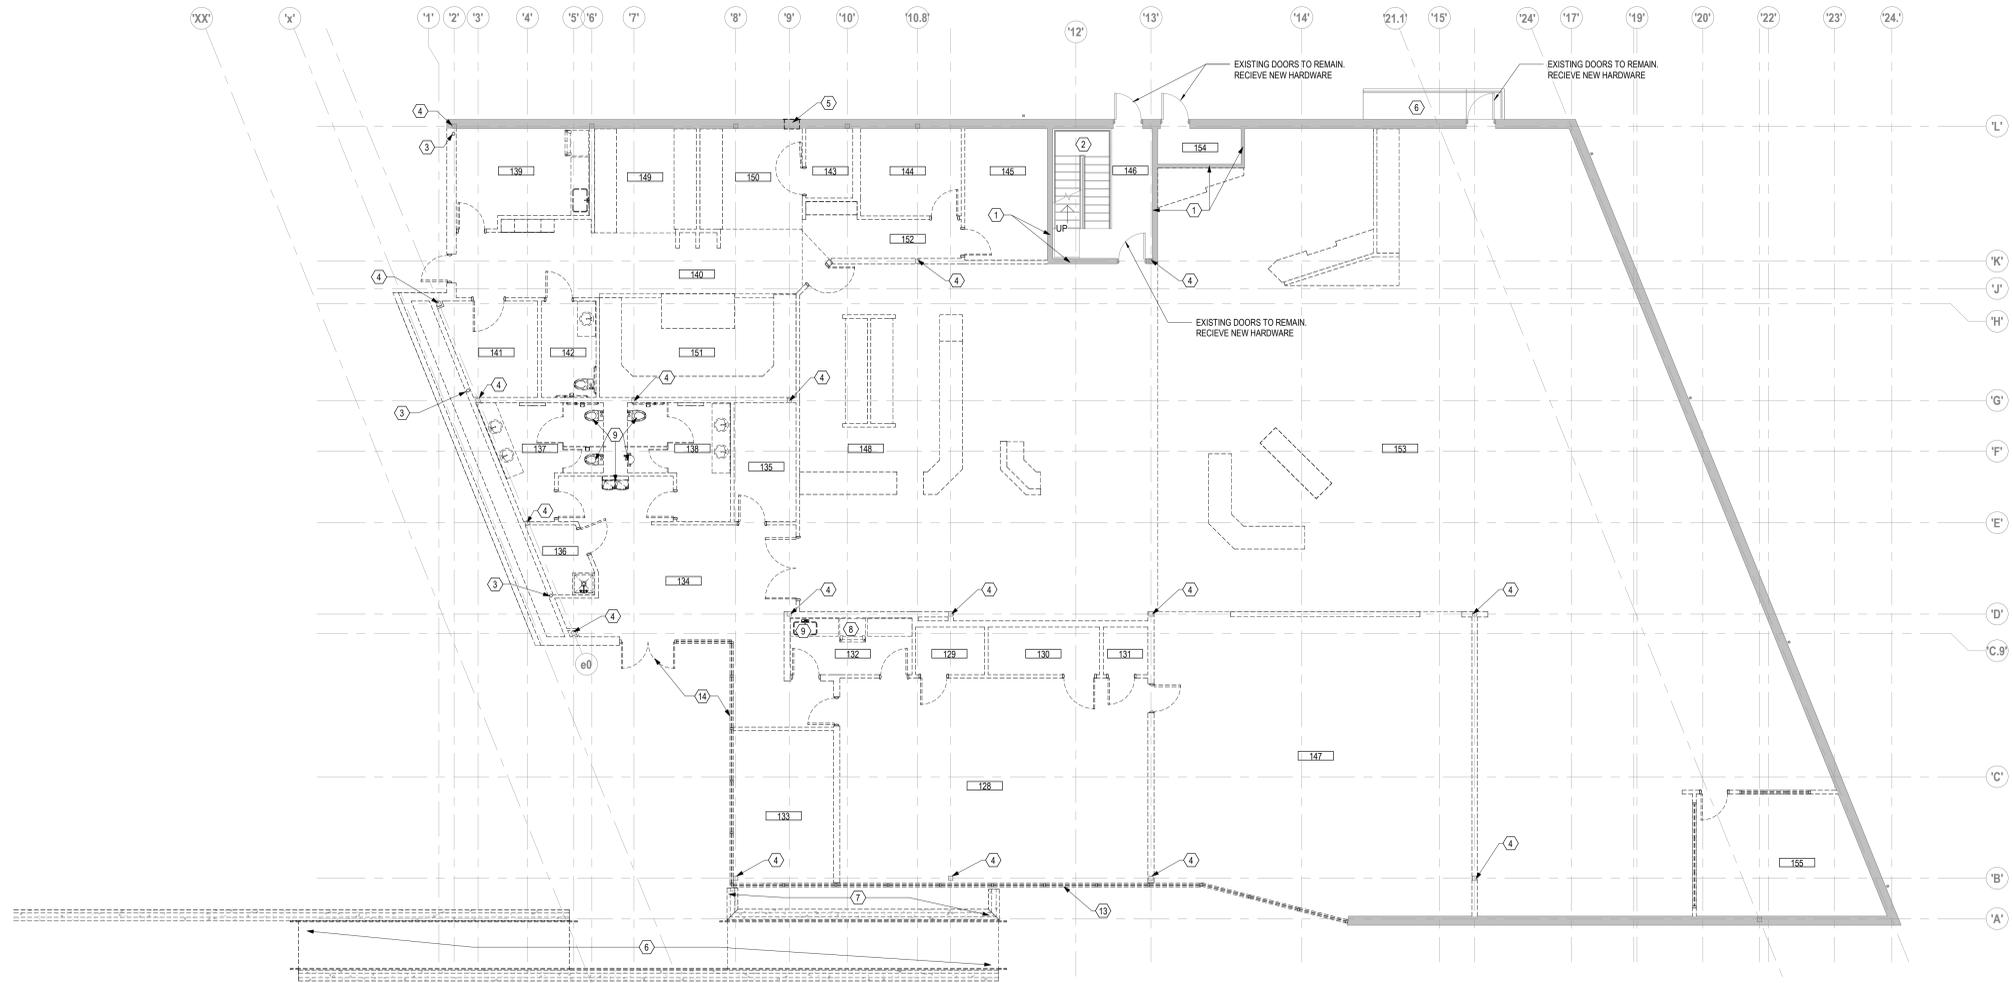


2 PLAN ROOF - DEMOLITION
1/8" = 1'-0"

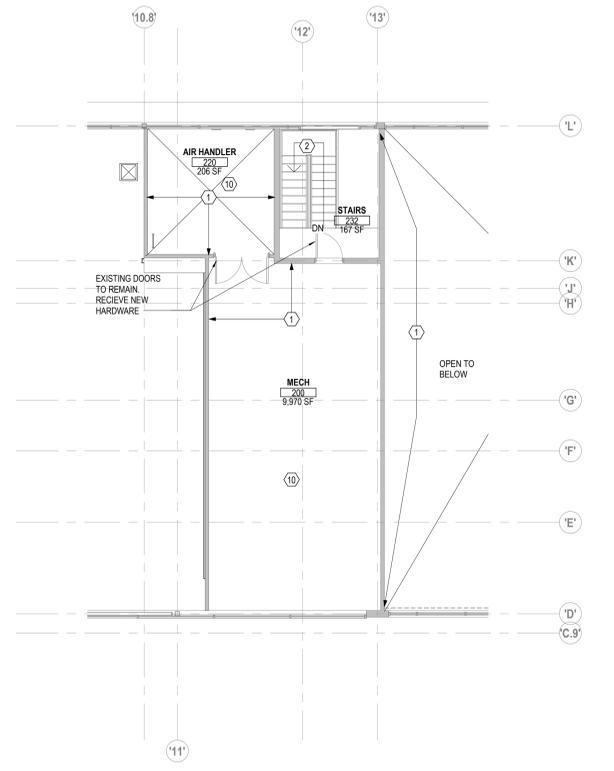

1 PLAN LEVEL 02M - DEMOLITION
1/8" = 1'-0"


CODED NOTES - DEMOLITION PLANS		GENERAL NOTES - DEMOLITION PLANS		#	DATE	CHANGE DESCRIPTION
<ol style="list-style-type: none"> EXISTING PARTITION TO REMAIN. PREPARE AS REQUIRED FOR NEW CONSTRUCTION EXISTING STAIRS TO REMAIN. PROTECT AND REPAIR DURING CONSTRUCTION EXISTING DOWNSPOUT, TO BE RELOCATED. PROVIDE PROTECTION DURING CONSTRUCTION EXISTING COLUMN TO REMAIN. PROVIDE PROTECTION DURING CONSTRUCTION EXISTING BOOK DROP TO BE REMOVED. INFILL TO MATCH EXISTING FACADE EXISTING RAMP TO REMAIN AND BE PROTECTED DURING CONSTRUCTION EXISTING PLANTER. REMOVE AND PREPARE SITE AS REQUIRED FOR NEW CONSTRUCTION REMOVE AND DISPOSE OF EXISTING CASEWORK REMOVE AND DISPOSE OF EXISTING PLUMBING FIXTURES REMOVE AND DISPOSE OF EXISTING ROOF TOP MEP AS REQUIRED PER MEP DRAWINGS REMOVE EXISTING ROOF. ROOF MEMBRANE & INSULATION CLEAN & REPAIR ROOF DECKING AS REQUIRED TO RECEIVE NEW ROOF INSULATION & MEMBRANE REMOVE C CHANNEL SUNSCREEN WHERE POSSIBLE EXISTING STOREFRONT TO BE REMOVED AND REPLACED WITH STOREFRONT AND GLASS TO MATCH NEW CONSTRUCTION REMOVE EXISTING STOREFRONT AND DOOR SYSTEM EXISTING "LIBRARY" SIGNAGE ON THE CANOPY TO BE SALVAGED AND REUSED 		<ol style="list-style-type: none"> X 				
<p>DEMOLITION LEGEND</p> <ul style="list-style-type: none"> XXX ROOM NUMBER — CONSTRUCTION TO REMAIN --- CONSTRUCTION TO BE REMOVED — DOOR TO REMAIN - - - DOOR TO BE REMOVED 						
<p>CML LINDEN BRANCH 2223 CLEVELAND AVE COLUMBUS, OH 43211 FOR COLUMBUS METROPOLITAN LIBRARY</p> <p>300 SPRUCE STREET SUITE 300 COLUMBUS, OHIO 43215 PHONE: (614) 461-4664 FAX: (614) 280-8881</p>				<p>NOVEMBER 21, 2023 DRAWN BY: XXXX CHECKED BY: XXXX Proj. # 21507.02 AD102 PERMIT SET</p>		

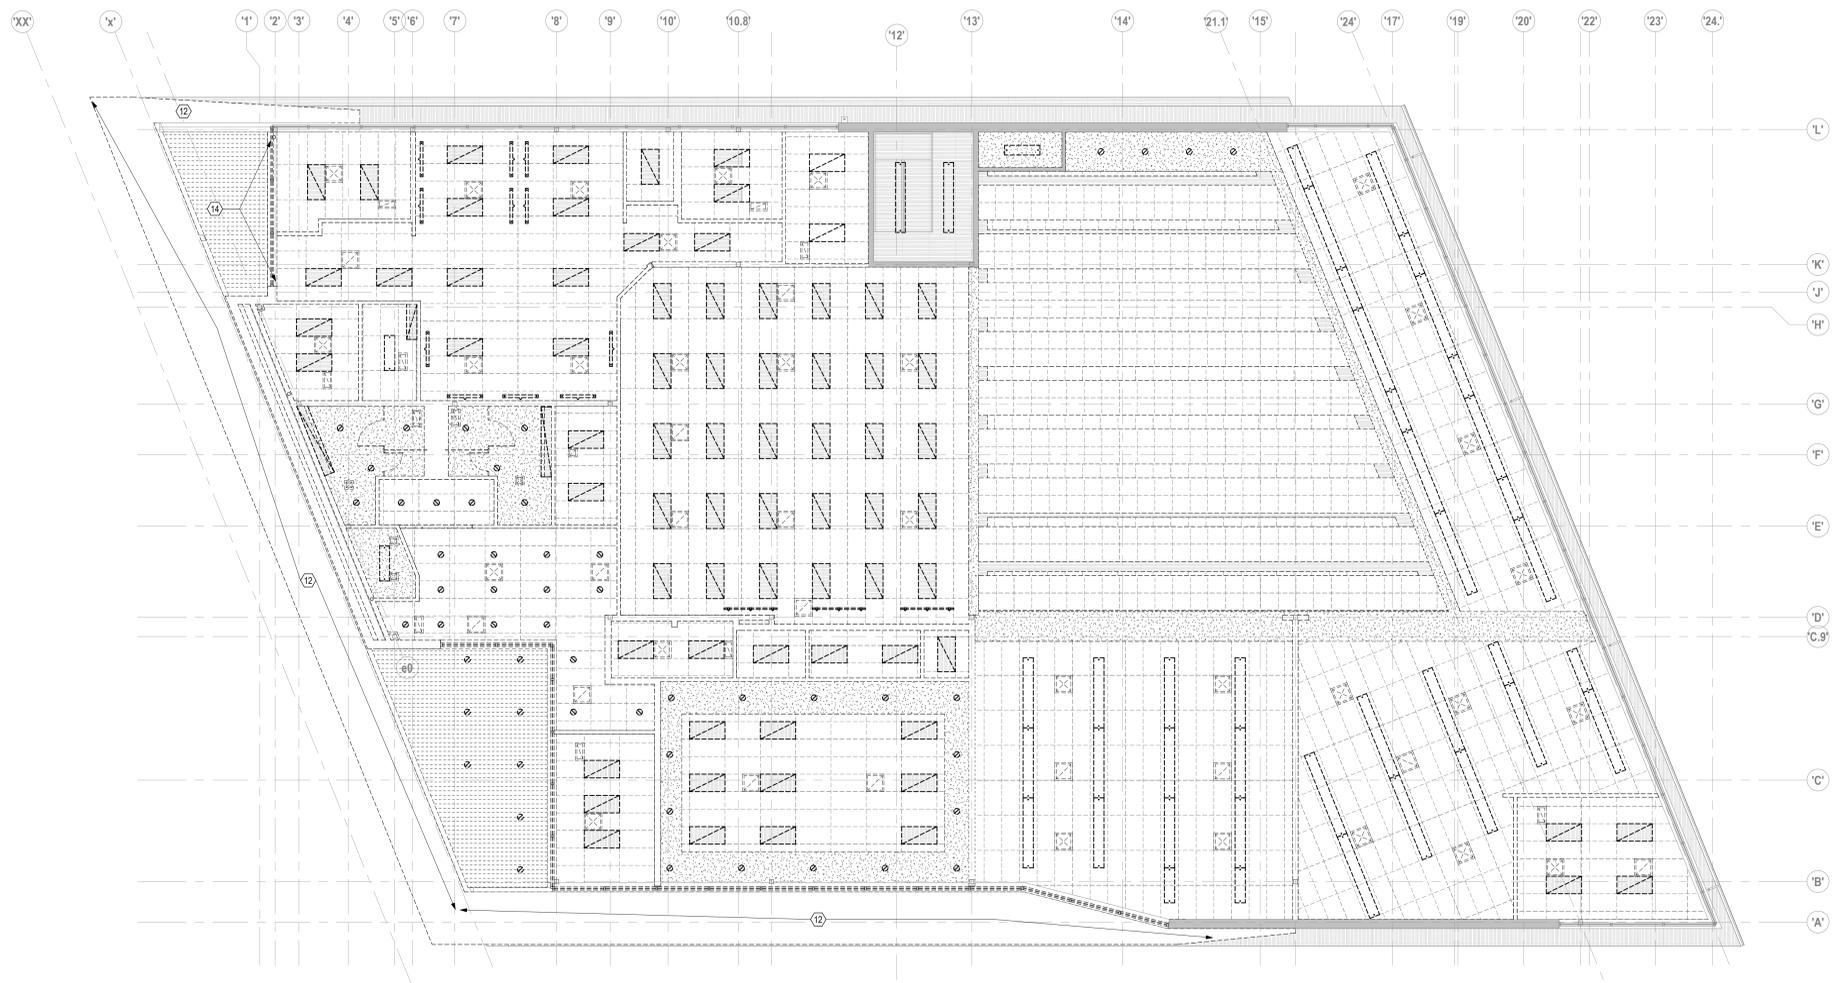

1 RCP OVERALL FIRST FLOOR DEMOLITION
1/8" = 1'-0"



CODED NOTES - DEMOLITION PLANS		GENERAL NOTES - DEMOLITION PLANS		#	DATE	CHANGE DESCRIPTION
1.	EXISTING PARTITION TO REMAIN. PREPARE AS REQUIRED FOR NEW CONSTRUCTION	KEY VALUE	KEYNOTE TEXT			
2.	EXISTING STAIRS TO REMAIN. PROTECT AND REPAIR DURING CONSTRUCTION	1.	X			
3.	EXISTING DOWNSPOUT, TO BE RELOCATED. PROVIDE PROTECTION DURING CONSTRUCTION					
4.	EXISTING COLUMN TO REMAIN. PROVIDE PROTECTION DURING CONSTRUCTION					
5.	EXISTING BOOK DROP TO BE REMOVED. INFILL TO MATCH EXISTING FACADE					
6.	EXISTING RAMP TO REMAIN AND BE PROTECTED DURING CONSTRUCTION					
7.	EXISTING PLASTER. REMOVE AND PREPARE SITE AS REQUIRED FOR NEW CONSTRUCTION					
8.	REMOVE AND DISPOSE OF EXISTING CASEWORK					
9.	REMOVE AND DISPOSE OF EXISTING PLUMBING FIXTURES					
10.	REMOVE AND DISPOSE OF EXISTING ROOF TOP MEP AS REQUIRED PER MEP DRAWINGS					
11.	REMOVE EXISTING ROOF. ROOF MEMBRANE & INSULATION CLEAN & REPAIR ROOF DECKING AS REQUIRED TO RECEIVE NEW ROOF INSULATION & MEMBRANE					
12.	REMOVE CHANNEL SUNSCREEN WHERE POSSIBLE					
13.	EXISTING STOREFRONT TO BE REMOVED AND REPLACED WITH STOREFRONT AND GLASS TO MATCH NEW CONSTRUCTION					
14.	REMOVE EXISTING STOREFRONT AND DOOR SYSTEM					
15.	EXISTING "LIBRARY" SIGNAGE ON THE CANOPY TO BE SALVAGED AND REUSED					
		DEMOLITION LEGEND				
	ROOM NUMBER					
	CONSTRUCTION TO REMAIN					
	CONSTRUCTION TO BE REMOVED					
	DOOR TO REMAIN					
	DOOR TO BE REMOVED					
				CML LINDEN BRANCH 2223 CLEVELAND AVE COLUMBUS, OH 43211 FOR COLUMBUS METROPOLITAN LIBRARY		
				300 SPRUCE STREET SUITE 300 COLUMBUS, OHIO 43215 PHONE: (614) 461-4664 FAX: (614) 280-8881		
				DRAWING TITLE: LEVEL 01 RCP - DEMOLITION PLAN		
				NOVEMBER 21, 2023 DRAWN BY: Author CHECKED BY: Checker Proj. # 21507.02		
				JONATHAN D. MOODY, LIC. #1215709 EXP. DATE: 12/31/2023		
				AD201 PERMIT SET		

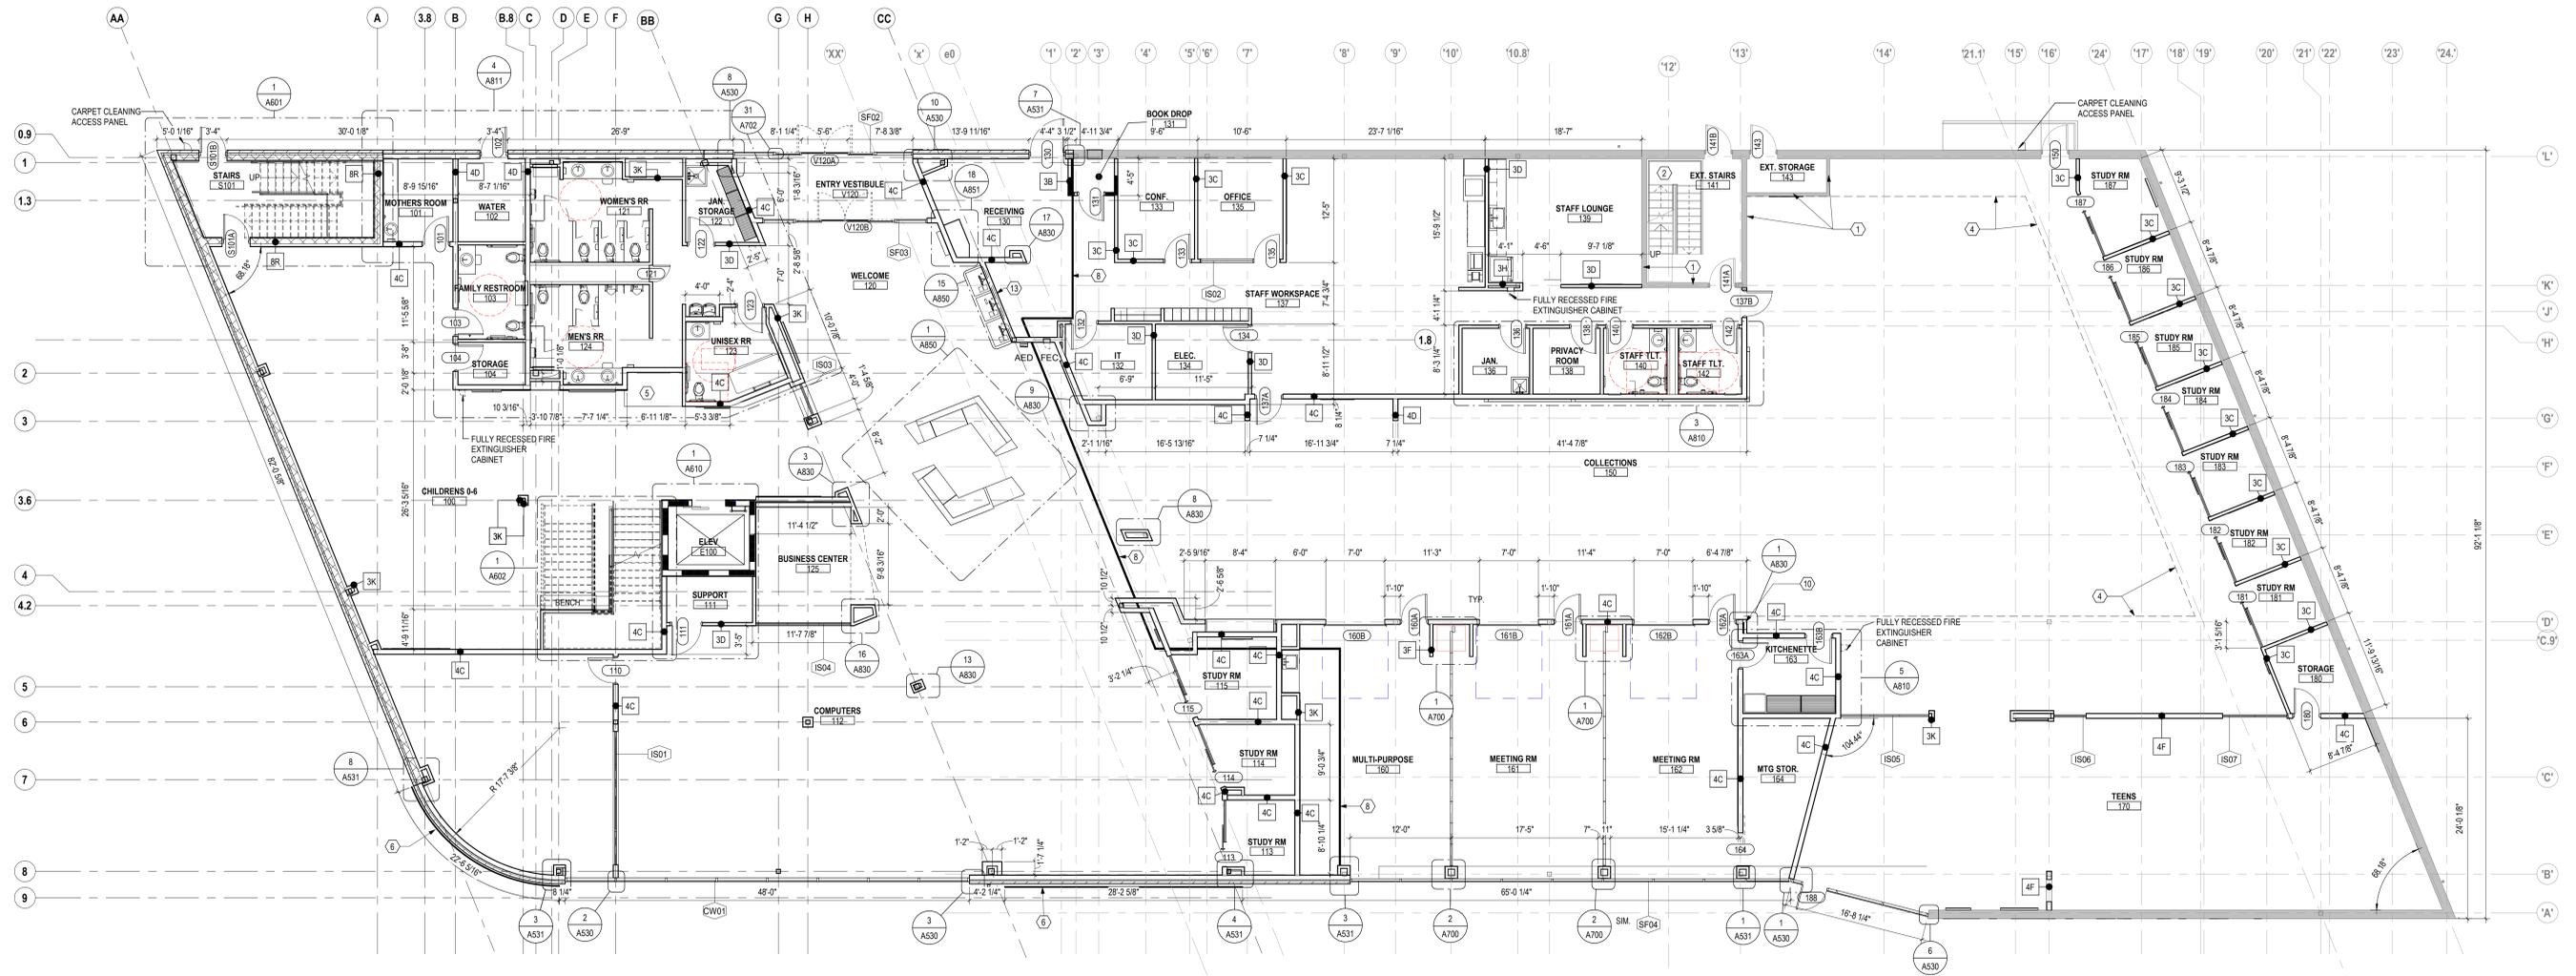

1 PLAN BUSINESS CENTER LEFT
 1/8" = 1'-0"

FLOOR PLAN GENERAL NOTES
1. ALL DIMENSIONS ARE TO FACE OF WALL (UNLESS NOTED OTHERWISE).
2. SEE STRUCTURAL DRAWINGS FOR LOCATIONS OF ALL STEEL REINFORCING IN WALL & FLOOR CONSTRUCTION.
3. SEE FINISH SCHEDULE FOR ADDITIONAL INFORMATION FOR LOCATIONS AND TYPES OF FINISH MATERIALS.
4. SEE ELEVATIONS AND STRUCTURAL DRAWINGS FOR LOCATIONS OF EXPANSION & CONTROL JOINTS. CONTRACTOR SHALL PROVIDE ADDITIONAL INTERIOR CONTROL JOINTS AS REQUIRED TO COMPLY WITH MAXIMUM SPACING REQUIREMENTS IN SPECIFICATIONS AND NATIONAL MASONRY INSTITUTE.
5. MECHANICAL & ELECTRICAL EQUIPMENT SHALL BE ON HOUSEKEEPING PADS. PADS ARE TO BE PROVIDED BY THE TRADE SUPPLYING THE EQUIPMENT. SEE MECHANICAL AND ELECTRICAL DRAWINGS FOR ADDITIONAL INFORMATION. WORK TO BE COORDINATED THROUGH THE GENERAL TRADES CONTRACTOR.
6. PROVIDE IN-WALL BLOCKING FOR ALL TOILET ACCESSORIES, GRAB BARS, ADJUSTABLE SHELVING, FIRE EXTINGUISHERS, TV MONITORS, ART WORK, CASEWORK, ETC. SEE INTERIOR ELEVATIONS FOR LOCATIONS OF TV MONITORS, ART WORK AND CASWORK.
7. REFER TO A700 SERIES FOR GLAZING ELEVATIONS.
8. SEE E201, E202 FOR FLOOR BOX LOCATIONS.

CODING NOTE LEGEND
1. EXISTING PARTITION TO REMAIN
2. EXISTING STAIRS TO REMAIN
3. 36" x 12" STAIR TYPE ROOF HATCH WITH RAILING SYSTEM & ALTERNATING TREAD STAIRS, SEE 1 / A540
4. CLERESTORY ABOVE
5. AQUARIUM SEE 9 / A822
6. PERFORATED METAL PANEL MURAL WALL
7. SEE LANDSCAPE FOR DIMENSIONS AND LOCATION OF AMENITY DECK FINISH MATERIALS
8. CONCRETE SLAB JOINT. SEE STRUCTURAL DRAWINGS
9. PROVIDE NEW FRESH AIR LOUVER. SEE 2 / A301 FOR DIMENSIONS
10. ALIGN PARTITION WITH EXISTING PARTITION ABOVE.
11. FIELD VERIFY LOCATION OF NEW PARTITIONS TO BE TIGHT TO DUCTWORK AS POSSIBLE
12. 30" WALKING PADS
13. PROVIDE WALL MOUNTED BIKE STORAGE RACK (CYCLOC, SOLO, COLOR BLACK) AT 6'-0" AFF, PROVIDE IN WALL BLOCKING TO SUPPORT RACK AND BIKE.

RATED WALL LEGEND
1 HOUR FIRE RATED PARTITION TO DECK

KEYNOTE LEGEND	
KEY VALUE	KEYNOTE TEXT
08 31 13.A1	CARPET CLEANING ACCESS PANEL
10 44 00.B2	FULLY RECESSED FIRE EXTINGUISHER CABINET

#	DATE	CHANGE DESCRIPTION

CML LINDEN BRANCH
 2223 CLEVELAND AVE
 COLUMBUS, OH 43211
 FOR
COLUMBUS METROPOLITAN LIBRARY


300 SPRUCE STREET
 SUITE 300
 COLUMBUS, OHIO 43215

PHONE: (614) 461-4664
 FAX: (614) 280-8881


DRAWING TITLE:
LEVEL 01 - FLOOR PLAN - OVERALL

NOVEMBER 21, 2023
 DRAWN BY: KG CHECKED BY: BL
 Proj. # 21507.02
A101
 PERMIT SET


JONATHAN D. MOODY, LIC. #1215709
 REGISTERED ARCHITECT

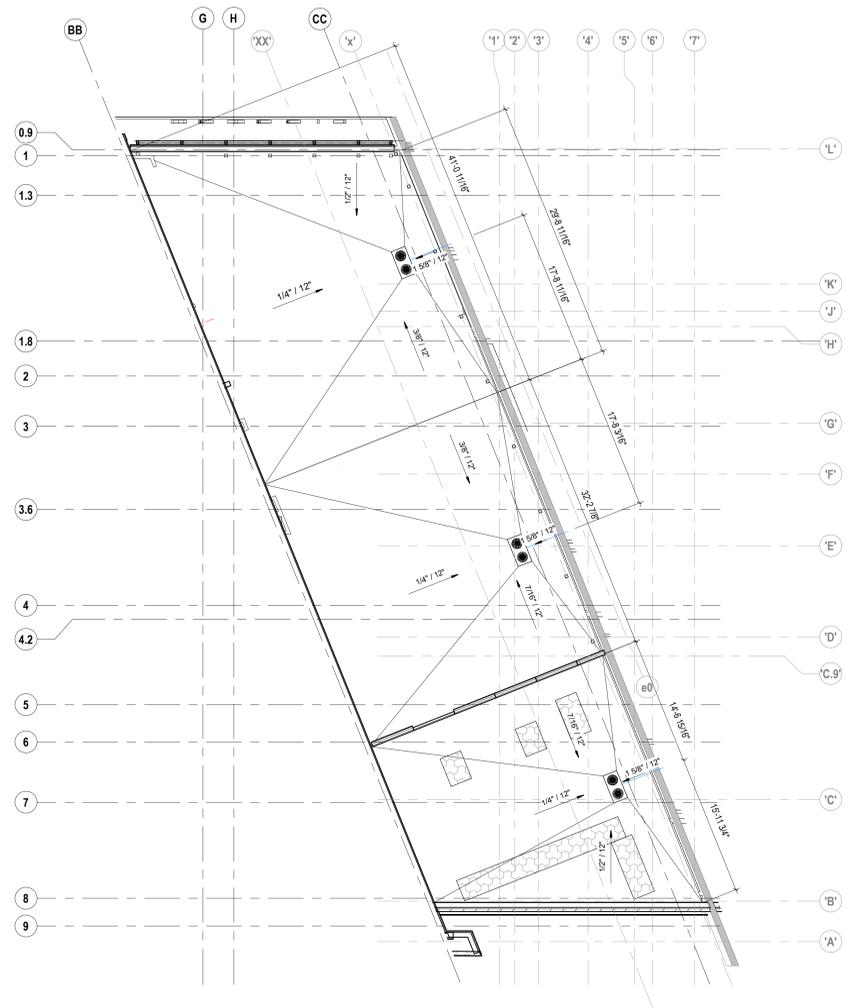


2 PLAN TERRACE DRAINAGE
1/8" = 1'-0"

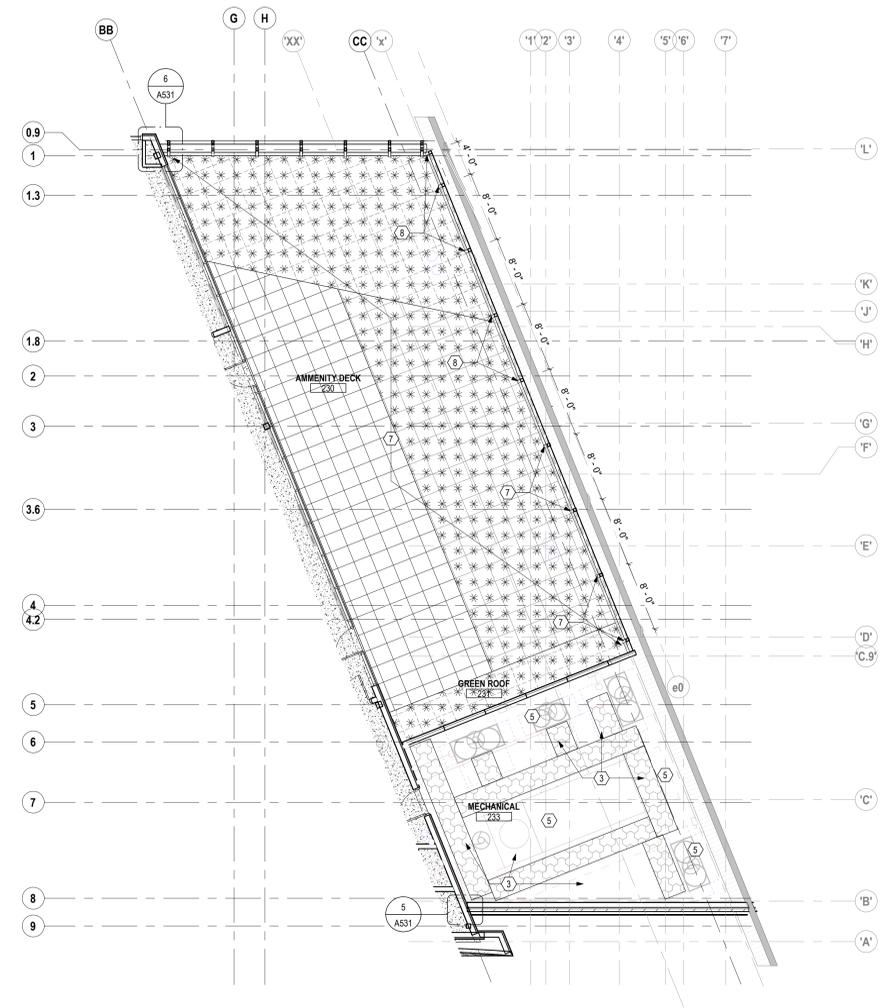


1 PLAN TERRACE
1/8" = 1'-0"

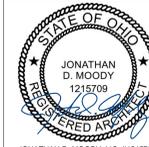ROOF PLAN GENERAL NOTES		KEYNOTE LEGEND		#	DATE	CHANGE DESCRIPTION
1. NOT USED		KEY VALUE	KEYNOTE TEXT			
ROOF PLAN CODED NOTES 1. WINDOW WASHING ANCHORS SEE 4 / A540 & STRUCTURAL DWGS 2. 36" x 72" STAIR TYPE ROOF HATCH WITH RAILING SYSTEM & ALTERNATING TREAD STAIRS, SEE 1 / A540 3. 30" WIDE WALKWAY PADS 4. EXHAUST FAN, SEE MECHANICAL DRAWINGS & ROOF DETAILS 5. ROOF TOP MECHANICAL EQUIPMENT 6. NEW TPO ROOF MEMBRANE & INSULATION 7. HSS TUBE CANOPY, SEE 6 / A523 8. HSS TUBE SCREEN WALL, SEE 5 / A522						
<div style="display: flex; justify-content: space-between; align-items: center;"> <div style="text-align: center;">  <p>CML LINDEN BRANCH 2223 CLEVELAND AVE COLUMBUS, OH 43211 FOR COLUMBUS METROPOLITAN LIBRARY</p> </div> <div style="text-align: center;">  <p>MOODY-NOLAN 300 SPRUCE STREET SUITE 300 COLUMBUS, OHIO 43215 PHONE: (614) 461-4664 FAX: (614) 280-8881</p> </div> </div>						
DRAWING TITLE:						
TERRACE						
					NOVEMBER 21, 2023 DRAWN BY: KG CHECKED BY: BL Proj. # 21507.02 <h1 style="margin: 0;">A110</h1> PERMIT SET	
JONATHAN D. MOODY, LIC. #1215709 EXP. DATE: 12/31/2023						

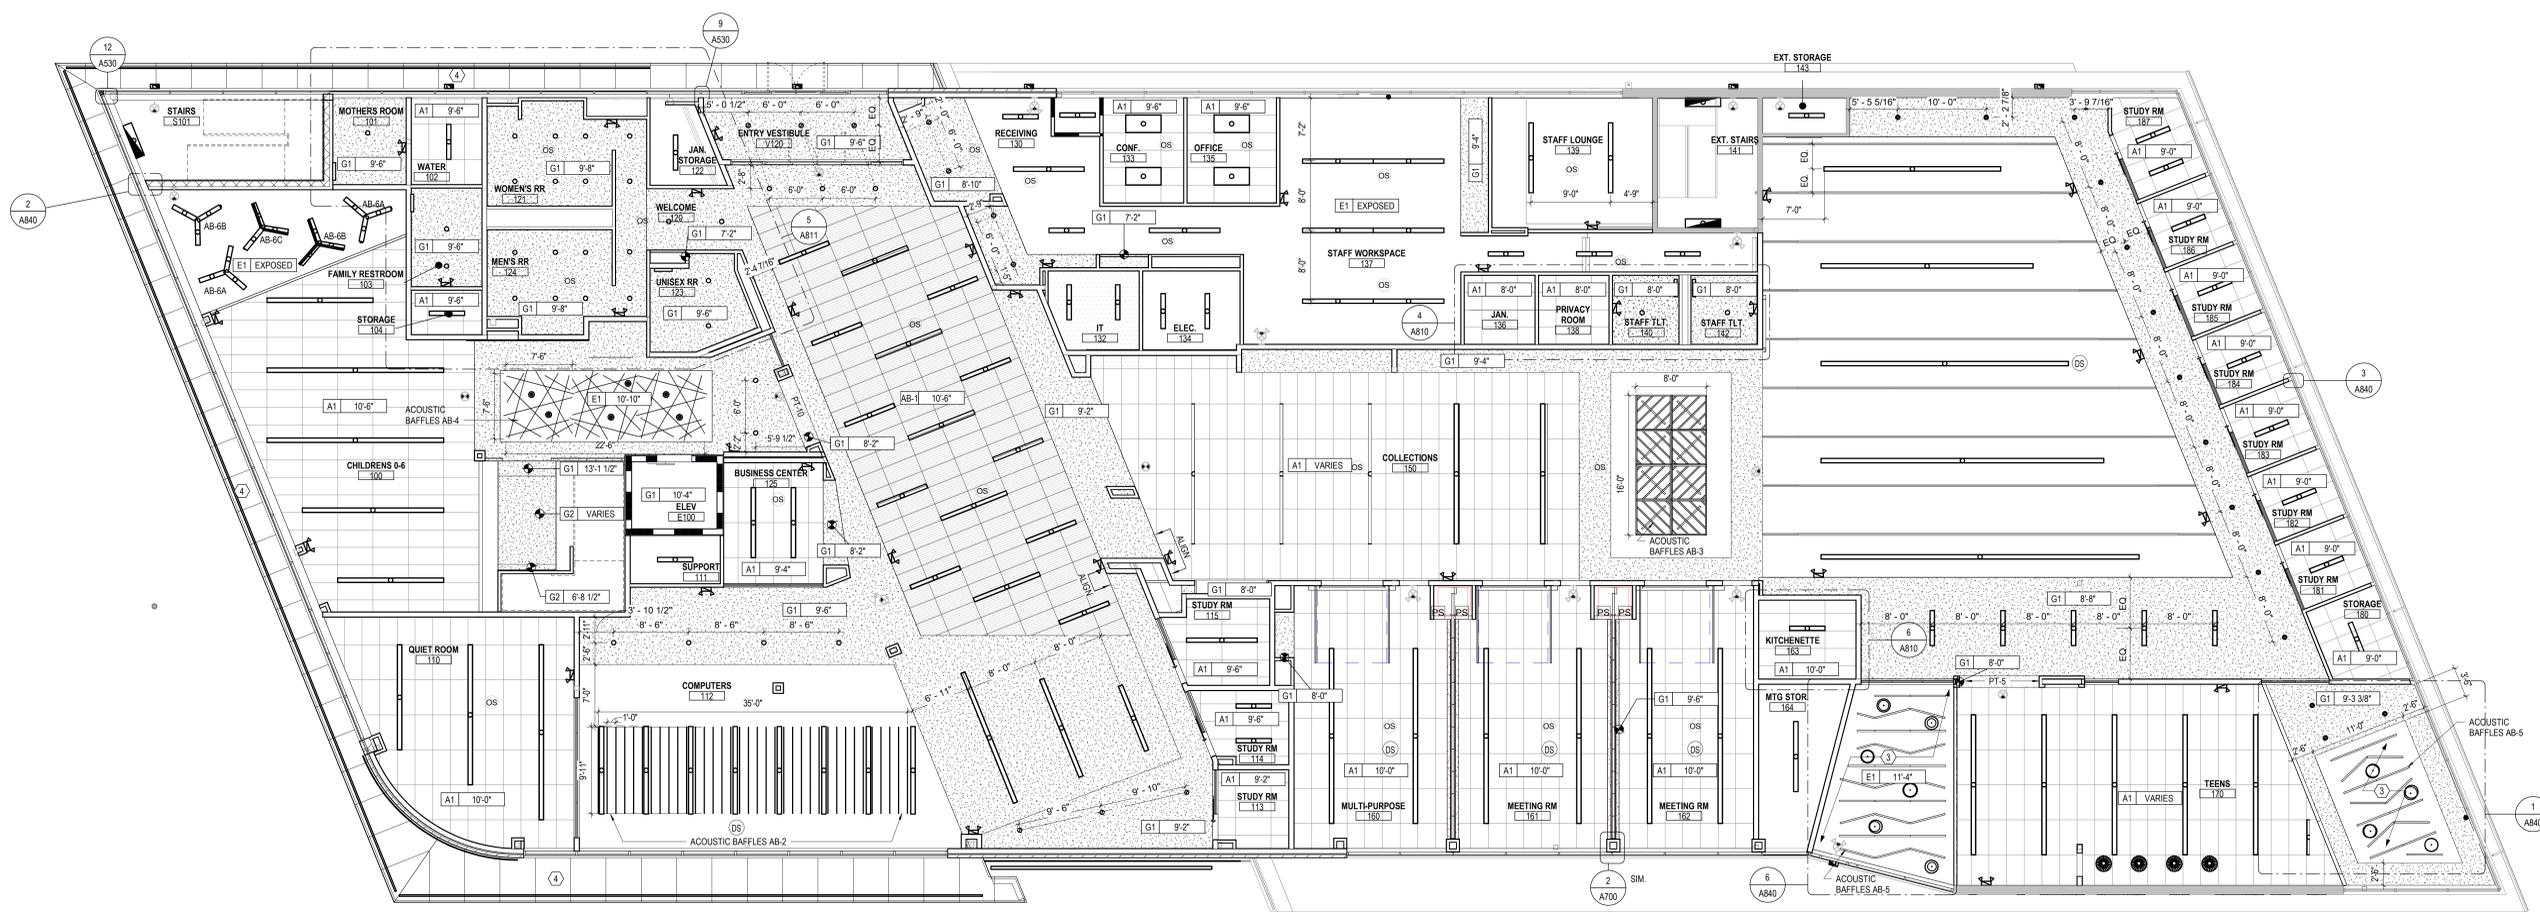

1 RCP OVERALL FIRST FLOOR RCP
1/8" = 1'-0"

RCP GENERAL NOTES		RCP LEGEND		CODED NOTE LEGEND		#	DATE	CHANGE DESCRIPTION		
<p>1. PAINT DESIGNATED FOR EXPOSED OVERHEAD STRUCTURE IS TO INCLUDE ALL EXPOSED COMPONENTS INCLUDING (BUT NOT EXCLUSIVE TO) DECKING, STRUCTURAL MEMBERS, MECHANICAL, AND ELECTRICAL DELIVERY SYSTEMS, FIRE PROTECTION SYSTEMS (EXCLUDING SPRINKLER HEADS), AND ALL OTHER MISCELLANEOUS BUILDING SYSTEMS LOCATED OVERHEAD. EACH OF THE AFOREMENTIONED CATEGORIES IS TO INCLUDE ANY AND ALL ASSOCIATED SUPPORTS, FASTENERS, HANGERS, STRUTS, BRACES, BRACKETS, ETC.</p> <p>2. LIGHT FIXTURES SHOWN TO INDICATE PROPOSED FIXTURES & GENERAL DESIGN INTENT.</p> <p>3. FINISHED CEILING HEIGHTS ARE MARKED FROM TOP OF FINISH FLOOR (UNLESS NOTED OTHERWISE).</p> <p>4. COORDINATE LOCATION OF FIXTURES WITH MECHANICAL, ELECTRICAL, PLUMBING, FIRE SUPPRESSION AND TECHNOLOGY DRAWINGS. ANY CONFLICT BETWEEN TRADES, NOTIFY ARCHITECT PRIOR TO INSTALLATION.</p> <p>5. FACE OF BULKHEADS ARE TO ALIGN WITH FACE OF ADJACENT WALLS TO WHICH BULKHEADS ARE PARALLEL, UNLESS NOTED OTHERWISE OR DIMENSIONED.</p> <p>6. ALL GYPSUM BOARD SOFFITS & CEILINGS TO BE PAINTED FLAT CEILING WHITE (UNLESS NOTED OTHERWISE).</p> <p>7. ALL GYPSUM SOFFITS IN FOOD SERVICE AREAS TO BE PAINTED WITH A SATIN FINISH.</p> <p>8. PAINT DUCTWORK INSIDE AIR GRILLES FLAT BLACK.</p> <p>9. CEILING GRIDS ARE CENTERED ON ROOM, U.N.O. OR DIMENSIONED.</p> <p>10. WHERE EXIT SIGNS OCCUR OVER A DOOR OR PAIR OF DOORS, CENTER SIGN ON DOOR OPENING.</p> <p>11. ALL CEILING DEVICES TO BE CENTERED IN TILE, U.N.O.</p>		<p>A1 ACOUSTIC CEILING TYPE 1: 2x4 LAY-IN CEILING</p> <p>A2 ACOUSTIC CEILING TYPE 2: 2x2 LAY-IN CEILING</p> <p>E1 EXPOSED STRUCTURE ABOVE</p> <p>G1 GYPSUM BOARD CEILING OR SOFFIT</p> <p>AP-1 ACOUSTICAL CEILING TILE</p> <p>M1 METAL COMPOSITE SOFFIT SYSTEM</p> <p>2x2 LIGHT FIXTURE (SHADING DENOTES EMERGENCY FIXTURE)</p> <p>2x4 LIGHT FIXTURE (SHADING DENOTES EMERGENCY FIXTURE)</p> <p>1x4 LIGHT FIXTURE (SHADING DENOTES EMERGENCY FIXTURE)</p> <p>1x8 LIGHT FIXTURE (SHADING DENOTES EMERGENCY FIXTURE)</p> <p>RECESSED CAN LIGHT</p> <p>SURFACE MOUNTED LIGHT</p> <p>LINEAR COVE LIGHT</p> <p>EXIT LIGHT WITH DIRECTIONAL ARROW</p> <p>EXIT LIGHT</p>		<p>⊗ SUPPLY DIFFUSER</p> <p>▬ LINEAR DIFFUSER</p> <p>⊘ EXHAUST/RETURN GRILLE</p> <p>⊙ SPEAKER</p> <p>XX XX'XX" CEILING TAG WITH HEIGHT</p> <p>NOTE: COORDINATE ARCHITECTURAL REFLECTED CEILING PLANS WITH THE MECHANICAL AND ELECTRICAL DRAWINGS FOR NUMBER OF, AND LOCATIONS OF, AND TYPES OF FIXTURES AND GRILLES. NOT ALL ITEMS SHOWN ON LEGEND MAY BE PRESENT IN PROJECT.</p>		<p>1. ALIGN FEATURES</p> <p>2. OPEN TO ABOVE</p> <p>3. PAINT EXPOSED CEILING AND DUCT WORK PT-4</p> <p>4. JOINT LINES OF ACM SOFFIT PANELS SHALL ALIGN WITH ACM FASCIA JOINT LINES</p>				
				<p>KEYNOTE LEGEND</p> <p>KEY VALUE KEYNOTE TEXT</p>						
				<p>MOODY-NOLAN</p> <p>300 SPRUCE STREET SUITE 300 COLUMBUS, OHIO 43215</p> <p>PHONE: (614) 461-4664 FAX: (614) 280-8881</p>						
				<p>STATE OF OHIO</p> <p>JONATHAN D. MOODY 1215709 REGISTERED ARCHITECT</p>						
				<p>LEVEL 01 - RCP - OVERALL</p>						
				<p>NOVEMBER 21, 2023</p> <p>DRAWN BY: KG CHECKED BY: BL</p> <p>Proj. # 21507.02</p> <p>A201</p> <p>PERMIT SET</p>						

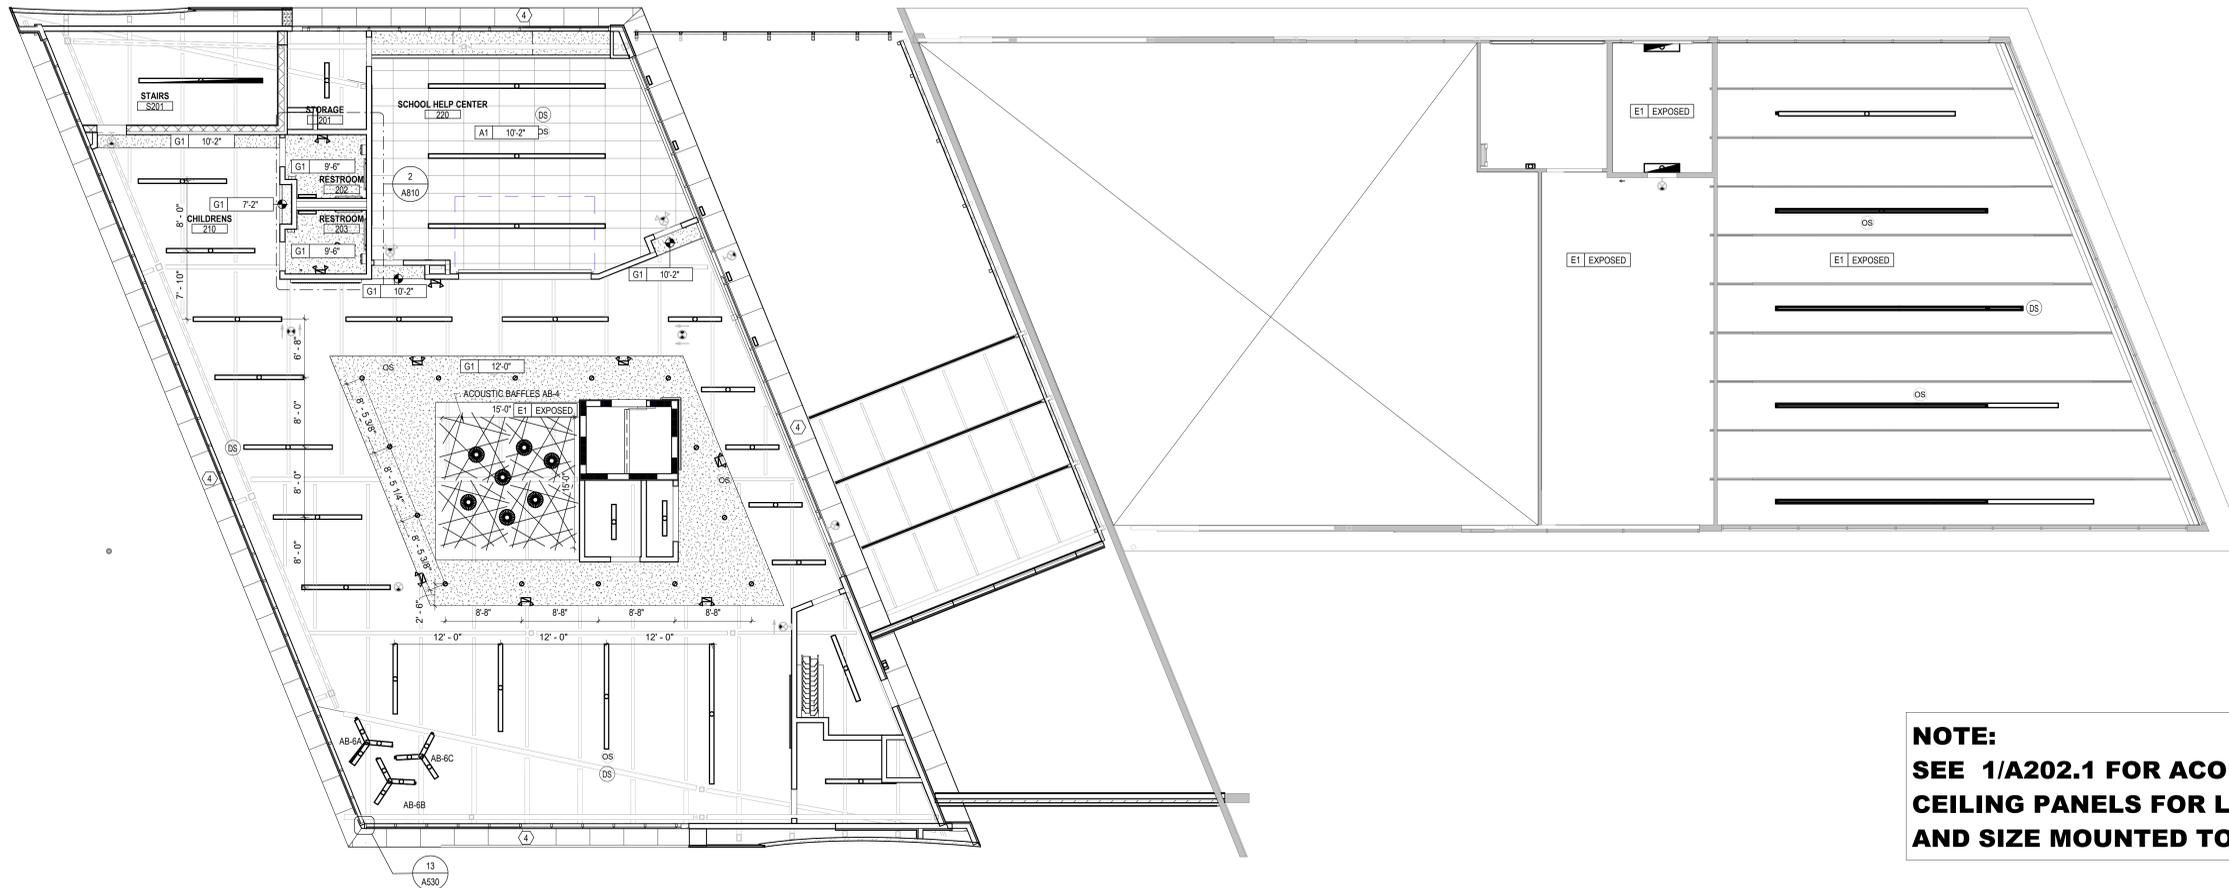

NOTE:
SEE 1/A202.1 FOR ACOUSTICAL CEILING PANELS FOR LOCATIONS AND SIZE MOUNTED TO ROOF DECK


1 RCP UPPER LEVEL
 1/8" = 1'-0"



RCP GENERAL NOTES		RCP LEGEND		CODED NOTE LEGEND		#	DATE	CHANGE DESCRIPTION	
1. PAINT DESIGNATED FOR EXPOSED OVERHEAD STRUCTURE IS TO INCLUDE ALL EXPOSED COMPONENTS INCLUDING (BUT NOT EXCLUSIVE TO) DECKING, STRUCTURAL MEMBERS, MECHANICAL, AND ELECTRICAL DELIVERY SYSTEMS, FIRE PROTECTION SYSTEMS (EXCLUDING SPRINKLER HEADS), AND ALL OTHER MISCELLANEOUS BUILDING SYSTEMS LOCATED OVERHEAD. EACH OF THE AFOREMENTIONED CATEGORIES IS TO INCLUDE ANY AND ALL ASSOCIATED SUPPORTS, FASTENERS, HANGERS, STRUTS, BRACES, BRACKETS, ETC.		A1 ACOUSTIC CEILING TYPE 1: 2x4 LAY-IN CEILING A2 ACOUSTIC CEILING TYPE 2: 2x2 LAY-IN CEILING E1 EXPOSED STRUCTURE ABOVE G1 GYPSUM BOARD CEILING OR SOFFIT AP-1 ACOUSTICAL CEILING TILE M1 METAL COMPOSITE SOFFIT SYSTEM		SUPPLY DIFFUSER LINEAR DIFFUSER EXHAUST/RETURN GRILLE SPEAKER CEILING TAG WITH HEIGHT NOTE: COORDINATE ARCHITECTURAL REFLECTED CEILING PLANS WITH THE MECHANICAL AND ELECTRICAL DRAWINGS FOR NUMBER OF, AND LOCATIONS OF, AND TYPES OF FIXTURES AND GRILLES. NOT ALL ITEMS SHOWN ON LEGEND MAY BE PRESENT IN PROJECT.		1. ALIGN FEATURES 2. OPEN TO ABOVE 3. PAINT EXPOSED CEILING AND DUCT WORK PT-4 4. JOINT LINES OF ACM SOFFIT PANELS SHALL ALIGN WITH ACM FASCIA JOINT LINES			
2. LIGHT FIXTURES SHOWN TO INDICATE PROPOSED FIXTURES & GENERAL DESIGN INTENT. 3. FINISHED CEILING HEIGHTS ARE MARKED FROM TOP OF FINISH FLOOR (UNLESS NOTED OTHERWISE). 4. COORDINATE LOCATION OF FIXTURES WITH MECHANICAL, ELECTRICAL, PLUMBING, FIRE SUPPRESSION AND TECHNOLOGY DRAWINGS. ANY CONFLICT BETWEEN TRADES, NOTIFY ARCHITECT PRIOR TO INSTALLATION. 5. FACE OF BULKHEADS ARE TO ALIGN WITH FACE OF ADJACENT WALLS TO WHICH BULKHEADS ARE PARALLEL, UNLESS NOTED OTHERWISE OR DIMENSIONED. 6. ALL GYPSUM BOARD SOFFITS & CEILINGS TO BE PAINTED FLAT CEILING WHITE (UNLESS NOTED OTHERWISE). 7. ALL GYPSUM SOFFITS IN FOOD SERVICE AREAS TO BE PAINTED WITH A SATIN FINISH. 8. PAINT DUCTWORK INSIDE AIR GRILLES FLAT BLACK. 9. CEILING GRIDS ARE CENTERED ON ROOM, U.N.O. OR DIMENSIONED. 10. WHERE EXIT SIGNS OCCUR OVER A DOOR OR PAIR OF DOORS, CENTER SIGN ON DOOR OPENING. 11. ALL CEILING DEVICES TO BE CENTERED IN TILE, U.N.O.		2x2 LIGHT FIXTURE (SHADING DENOTES EMERGENCY FIXTURE) 2x4 LIGHT FIXTURE (SHADING DENOTES EMERGENCY FIXTURE) 1x4 LIGHT FIXTURE (SHADING DENOTES EMERGENCY FIXTURE) 1x8 LIGHT FIXTURE (SHADING DENOTES EMERGENCY FIXTURE) RECESSED CAN LIGHT SURFACE MOUNTED LIGHT LINEAR COVE LIGHT EXIT LIGHT WITH DIRECTIONAL ARROW EXIT LIGHT		KEYNOTE LEGEND KEY VALUE KEYNOTE TEXT					
				MOODY-NOLAN 300 SPRUCE STREET SUITE 300 COLUMBUS, OHIO 43215 PHONE: (614) 461-4664 FAX: (614) 280-8881					
				DRAWING TITLE: LEVEL 02 - RCP - OVERALL					
				NOVEMBER 21, 2023 DRAWN BY: KG CHECKED BY: BL Proj. # 21507.02 A202 PERMIT SET					

ACOUSTICAL TREATMENT QUANTITY	
Type	Area
AP-1 Acoustical Panel Ceiling	2,499 SF


COORDINATE PLACEMENT OF ACOUSTICAL PANELS WITH POWER AND SUSPENSION POINTS FOR LIGHT FIXTURES. SUSPENSION CABLES TO FALL BETWEEN PANELS WHEREVER POSSIBLE.

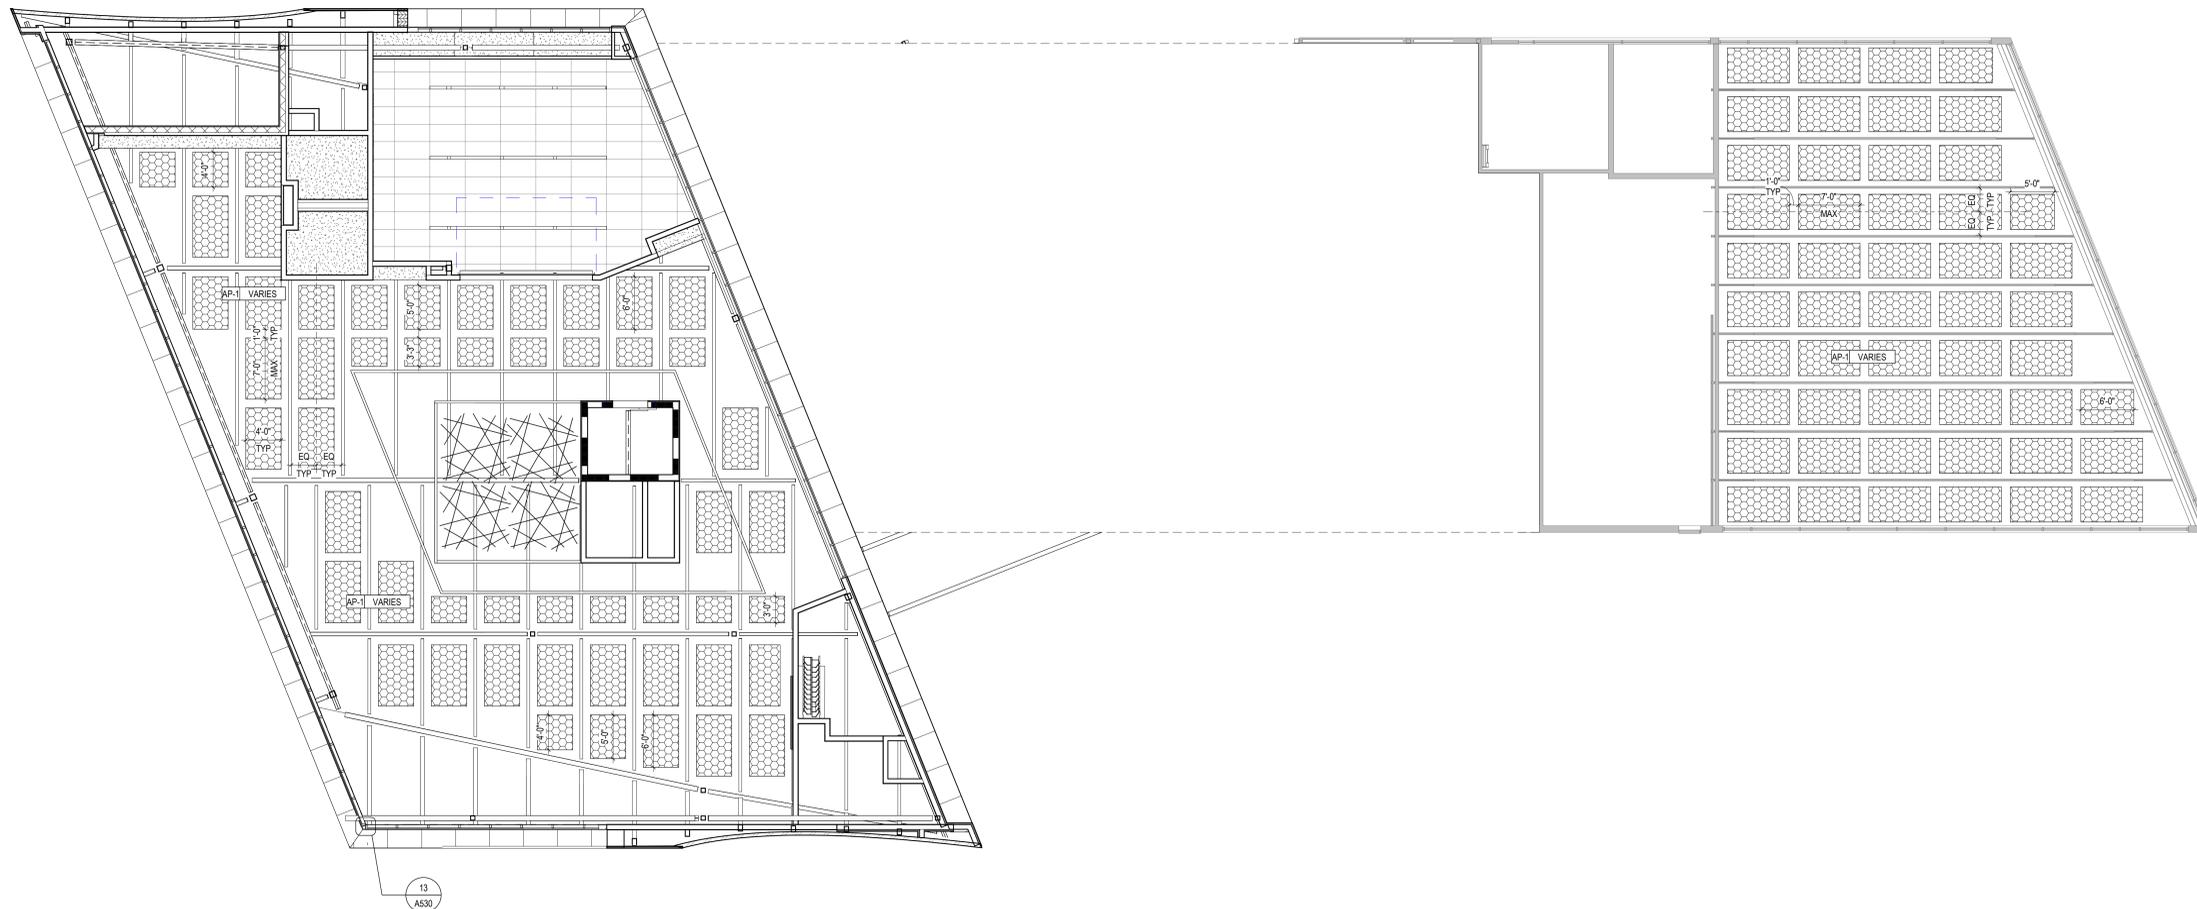

1 RCP UPPER LEVEL ACOUSTIC
1/8" = 1'-0"




RCP GENERAL NOTES	RCP LEGEND	CODED NOTE LEGEND	#	DATE	CHANGE DESCRIPTION
<p>1. PAINT DESIGNATED FOR EXPOSED OVERHEAD STRUCTURE IS TO INCLUDE ALL EXPOSED COMPONENTS INCLUDING (BUT NOT EXCLUSIVE TO) DECKING, STRUCTURAL MEMBERS, MECHANICAL, AND ELECTRICAL DELIVERY SYSTEMS, FIRE PROTECTION SYSTEMS (EXCLUDING SPRINKLER HEADS), AND ALL OTHER MISCELLANEOUS BUILDING SYSTEMS LOCATED OVERHEAD. EACH OF THE AFOREMENTIONED CATEGORIES IS TO INCLUDE ANY AND ALL ASSOCIATED SUPPORTS, FASTENERS, HANGERS, STRUTS, BRACES, BRACKETS, ETC.</p> <p>2. LIGHT FIXTURES SHOWN TO INDICATE PROPOSED FIXTURES & GENERAL DESIGN INTENT.</p> <p>3. FINISHED CEILING HEIGHTS ARE MARKED FROM TOP OF FINISH FLOOR (UNLESS NOTED OTHERWISE).</p> <p>4. COORDINATE LOCATION OF FIXTURES WITH MECHANICAL, ELECTRICAL, PLUMBING, FIRE SUPPRESSION AND TECHNOLOGY DRAWINGS. ANY CONFLICT BETWEEN TRADES, NOTIFY ARCHITECT PRIOR TO INSTALLATION.</p> <p>5. FACE OF BULKHEADS ARE TO ALIGN WITH FACE OF ADJACENT WALLS TO WHICH BULKHEADS ARE PARALLEL, UNLESS NOTED OTHERWISE OR DIMENSIONED.</p> <p>6. ALL GYPSUM BOARD SOFFITS & CEILINGS TO BE PAINTED FLAT CEILING WHITE (UNLESS NOTED OTHERWISE).</p> <p>7. ALL GYPSUM SOFFITS IN FOOD SERVICE AREAS TO BE PAINTED WITH A SATIN FINISH.</p> <p>8. PAINT DUCTWORK INSIDE AIR GRILLES FLAT BLACK.</p> <p>9. CEILING GRIDS ARE CENTERED ON ROOM, U.N.O. OR DIMENSIONED.</p> <p>10. WHERE EXIT SIGNS OCCUR OVER A DOOR OR PAIR OF DOORS, CENTER SIGN ON DOOR OPENING.</p> <p>11. ALL CEILING DEVICES TO BE CENTERED IN TILE, U.N.O.</p>	<p>RCP LEGEND</p> <p>A1 ACOUSTIC CEILING TYPE 1: 2x4 LAY-IN CEILING</p> <p>A2 ACOUSTIC CEILING TYPE 2: 2x2 LAY-IN CEILING</p> <p>E1 EXPOSED STRUCTURE ABOVE</p> <p>G1 GYPSUM BOARD CEILING OR SOFFIT</p> <p>AP-1 ACOUSTICAL CEILING TILE</p> <p>M1 METAL COMPOSITE SOFFIT SYSTEM</p> <p>2x2 LIGHT FIXTURE (SHADING DENOTES EMERGENCY FIXTURE)</p> <p>2x4 LIGHT FIXTURE (SHADING DENOTES EMERGENCY FIXTURE)</p> <p>1x4 LIGHT FIXTURE (SHADING DENOTES EMERGENCY FIXTURE)</p> <p>1x8 LIGHT FIXTURE (SHADING DENOTES EMERGENCY FIXTURE)</p> <p>RECESSED CAN LIGHT</p> <p>SURFACE MOUNTED LIGHT</p> <p>LINEAR COVE LIGHT</p> <p>EXIT LIGHT WITH DIRECTIONAL ARROW</p> <p>EXIT LIGHT</p>	<p>CODED NOTE LEGEND</p> <p>1. ALIGN FEATURES</p> <p>2. OPEN TO ABOVE</p> <p>3. PAINT EXPOSED CEILING AND DUCT WORK PT-4</p> <p>4. JOINT LINES OF ACM SOFFIT PANELS SHALL ALIGN WITH ACM FASCIA JOINT LINES</p> <p>KEYNOTE LEGEND</p> <p>KEY VALUE</p> <p>KEYNOTE TEXT</p>			
					<p>CML LINDEN BRANCH 2223 CLEVELAND AVE COLUMBUS, OH 43211 FOR COLUMBUS METROPOLITAN LIBRARY</p> <p>300 SPRUCE STREET SUITE 300 COLUMBUS, OHIO 43215</p> <p>PHONE: (614) 461-4664 FAX: (614) 280-8881</p>
					<p>DRAWING TITLE: LEVEL 02- ACOUSTICAL TREATMENT</p> <p>NOVEMBER 21, 2023</p> <p>DRAWN BY: KG CHECKED BY: BL</p> <p>Proj. # 21507.02</p> <p>A202.1</p> <p>PERMIT SET</p>

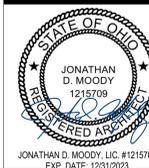





4 AXONOMETRIC NORTH-WEST

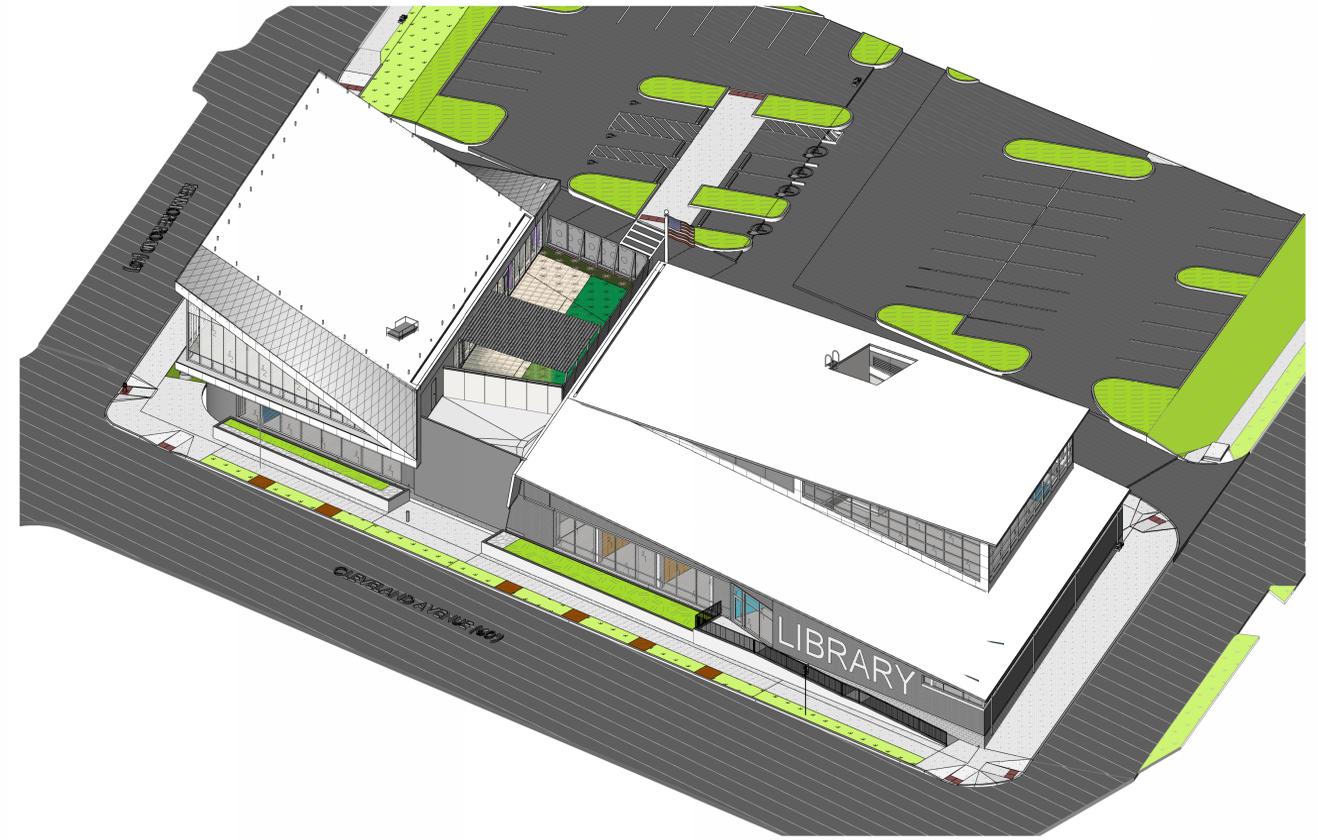

2 AXONOMETRIC NORTH-EAST

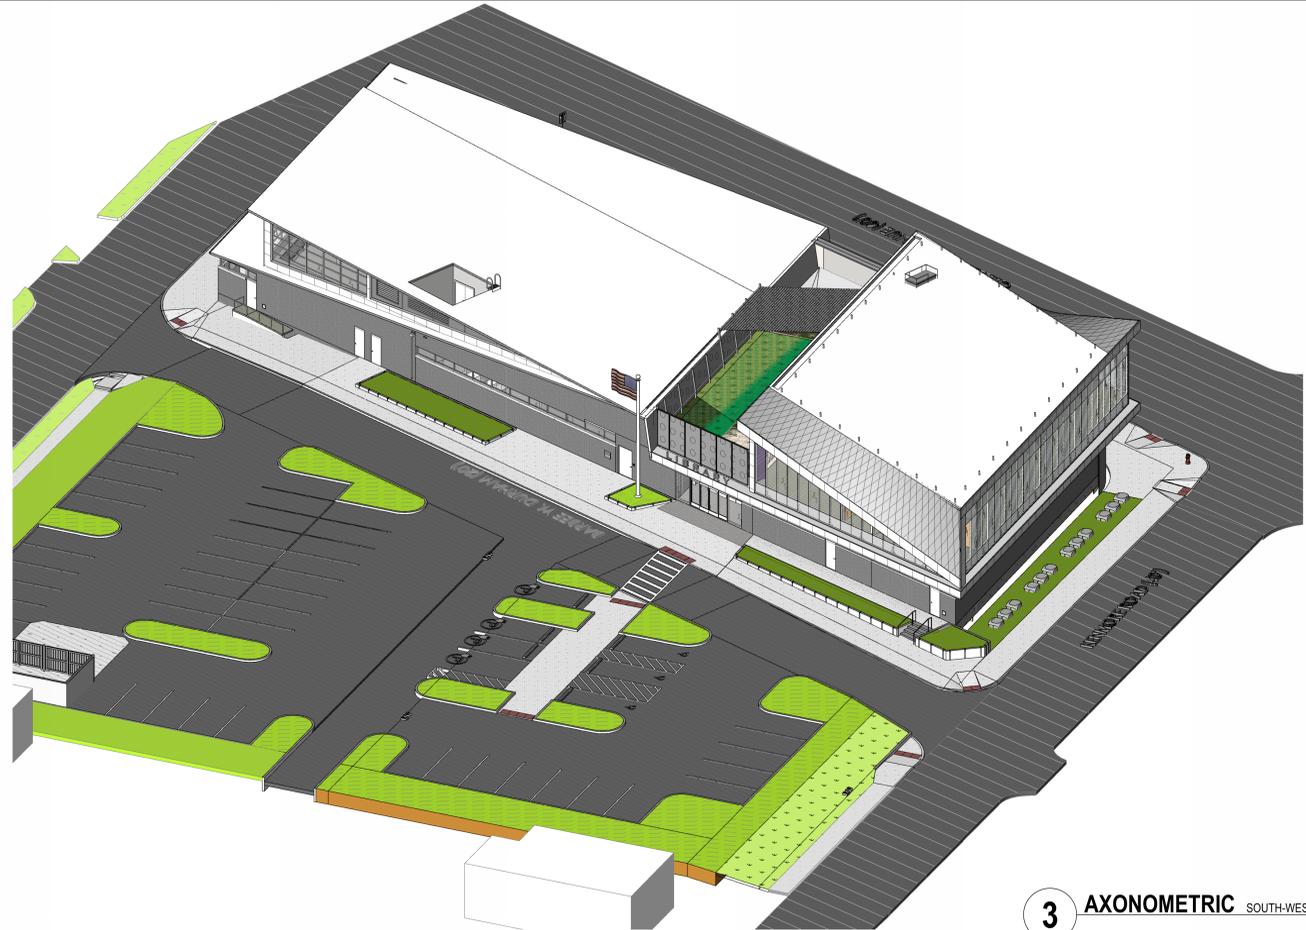

3 AXONOMETRIC SOUTH-WEST

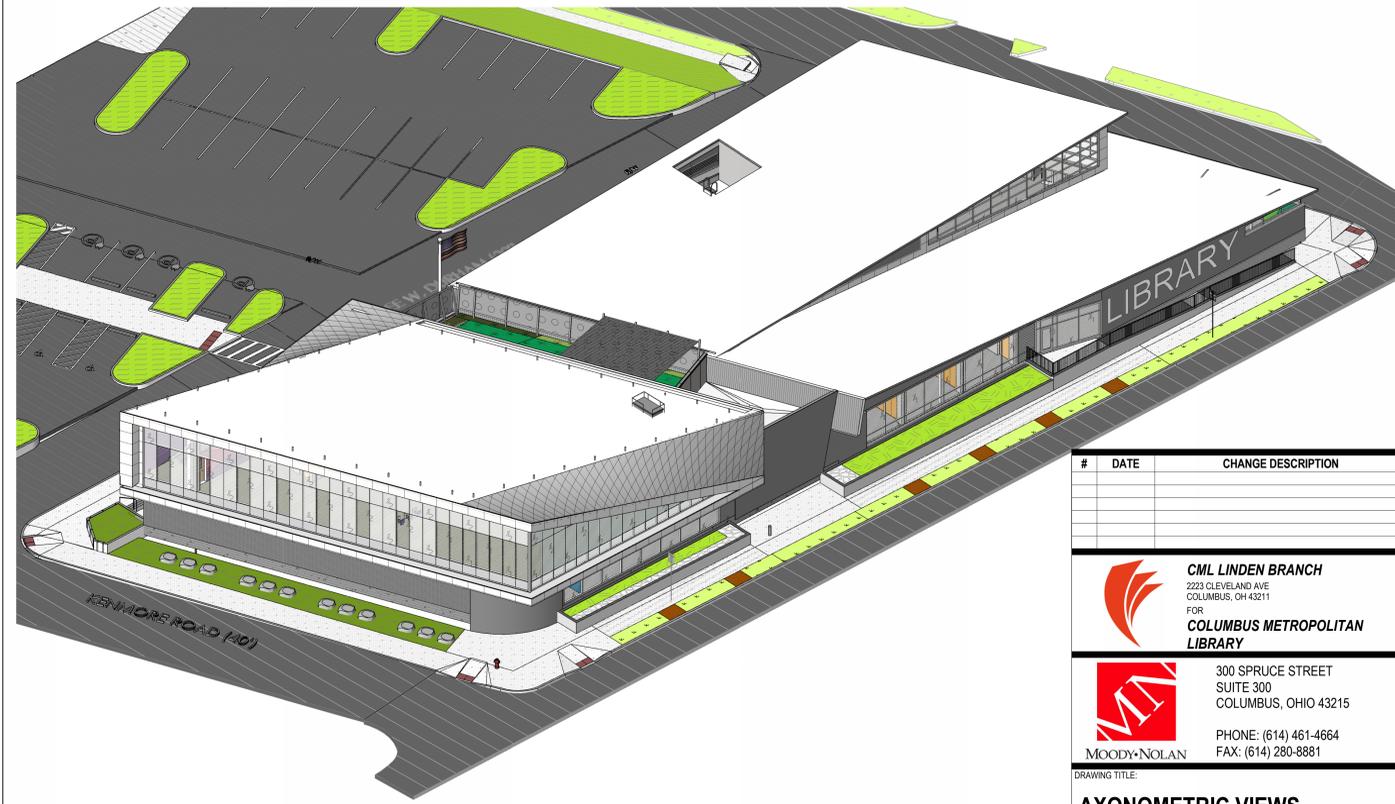


1 AXONOMETRIC SOUTH-EAST

#	DATE	CHANGE DESCRIPTION


CML LINDEN BRANCH
 2223 CLEVELAND AVE
 COLUMBUS, OH 43211
 FOR
COLUMBUS METROPOLITAN LIBRARY

MOODY-NOLAN
 300 SPRUCE STREET
 SUITE 300
 COLUMBUS, OHIO 43215
 PHONE: (614) 461-4664
 FAX: (614) 280-8881


DRAWING TITLE:
AXONOMETRIC VIEWS

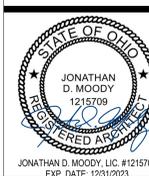


NOVEMBER 21, 2023
 DRAWN BY: KG CHECKED BY: BL
 Proj. # 21507.02
A300
 PERMIT SET

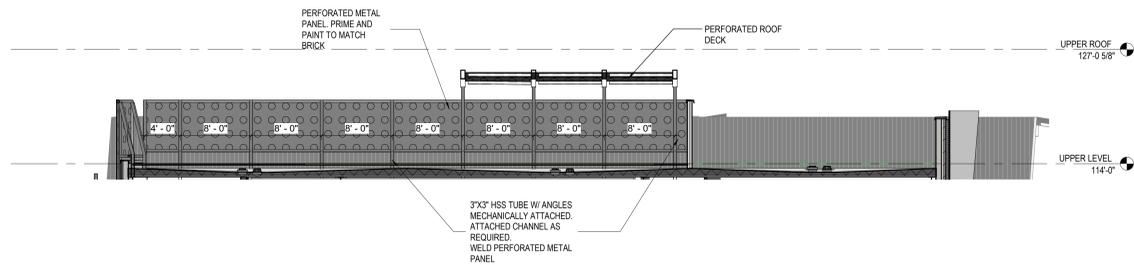


4 ELEVATION NORTH FACADE - OUTDOOR TERRACE
1/8" = 1'-0"

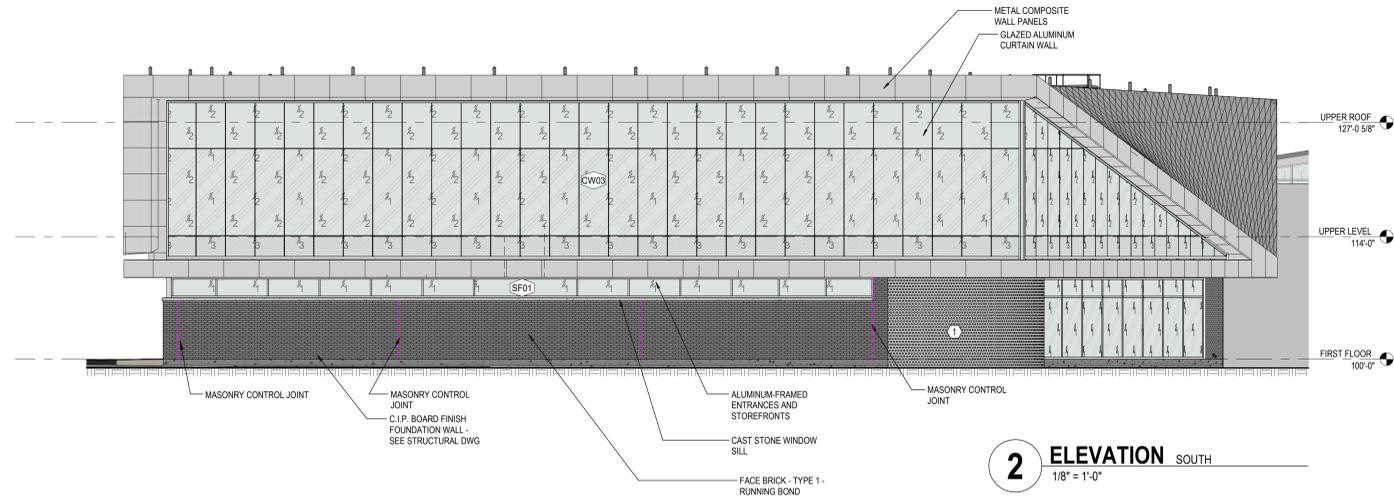


2 ELEVATION SOUTH
1/8" = 1'-0"

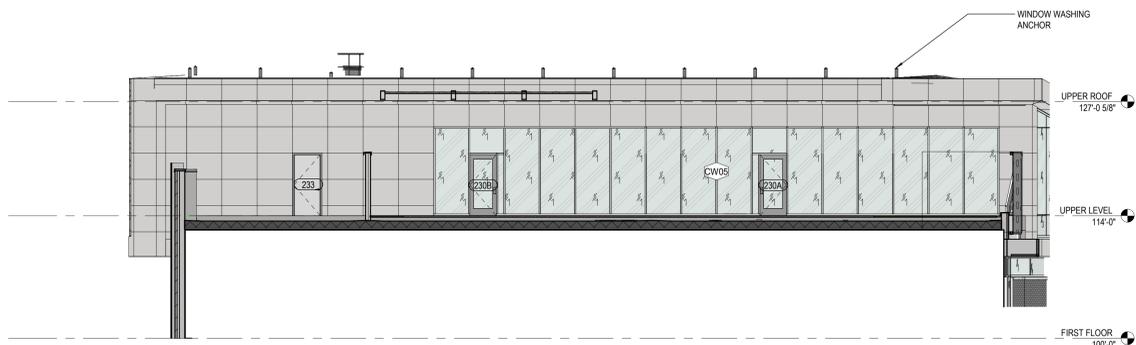


3 ELEVATION SOUTH FACADE - OUTDOOR TERRACE
1/8" = 1'-0"

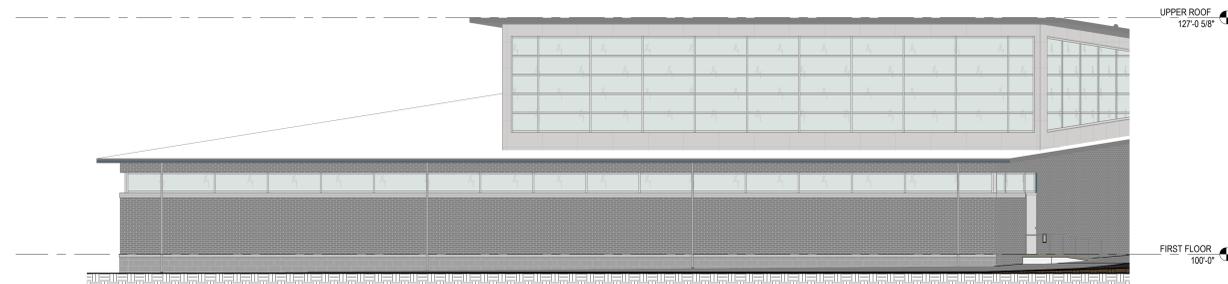

1 ELEVATION ELEVATION - NORTH
1/8" = 1'-0"

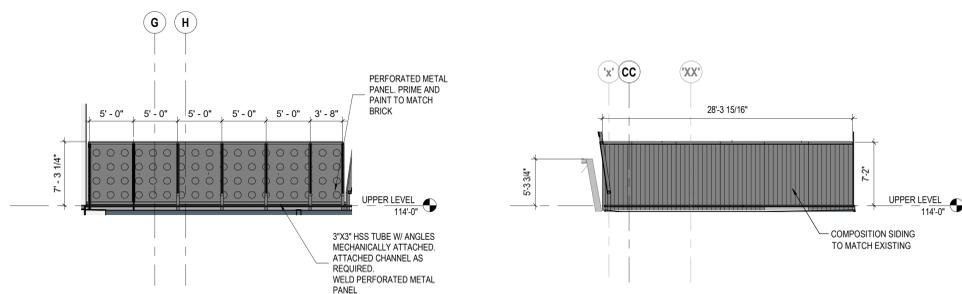

6 ELEVATION PERF METAL GUARD
1/8" = 1'-0"

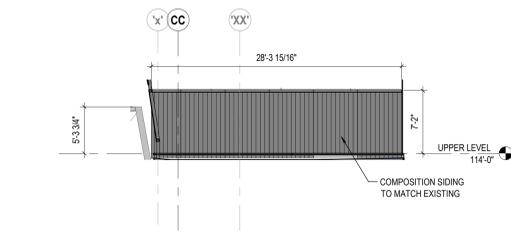

5 ELEVATION SCREEN WALL
1/8" = 1'-0"

GENERAL NOTES - EXTERIOR ELEVATIONS

1. ALL FACE BRICK TO BE PAINTED SAME COLOR TBD BY OWNER

CODED NOTES - EXTERIOR ELEVATIONS

1. WALL WILL RECEIVE LARGE ART (TBD) PLACED ON PERFORATED METAL PANEL. PREP WALL AS REQUIRED
2. WALL TO BE PAINTED 'LIBRARY' GRAPHIC, COLOR WHITE, SEE 3 / A301
3. ALIGN TOP OF COPING TO SAME ELEVATION AS EXISTING WALL
4. JOINT LINES OF ACM SOFFIT PANELS SHALL ALIGN WITH ACM FASCIA JOINT LINES
5. EXPOSED EXISTING STEEL LITTEL, PRIME AND PAINT TO MATCH BRICK
6. EXISTING LOUVER, BLANK OFF AS REQUIRED
7. CUT AND INSTALL NEW OPEN LOUVER AS REQUIRED, SEE MECHANICAL FOR SIZE
8. EXISTING DIMENSIONAL LETTERING, INSTALL AS REQUIRED

EXTERIOR ELEVATIONS LEGEND

	IG-1 EXTERIOR INSULATED GLAZING		DIAMOND TILE SHINGLES
	IG-1A EXTERIOR INSULATED GLAZING (TEMPERED)		BRICK TYPE 1 - RUNNING BOND PAINTED
	IG-2 EXTERIOR INSULATED GLAZING (FRITTED)		EXISTING BRICK - PAINTED
	IG-2A EXTERIOR INSULATED GLAZING (FRITTED - TEMPERED)		ALUMINUM COMPOSITE METAL PANEL
	IG-3 EXTERIOR INSULATED GLAZING (SPANDREL)		MASONRY CONTROL JOINT

KEYNOTE LEGEND

KEY VALUE	KEYNOTE TEXT
03 30 00.D4	C.I.P. BOARD FINISH FOUNDATION WALL - SEE STRUCTURAL DWG
04 00 00.B1A	FACE BRICK - TYPE 1 - RUNNING BOND
04 00 00.X1F	MASONRY CONTROL JOINT
04 72 00.A4	CAST STONE WINDOW SILL
07 41 13.C	PERFORATED ROOF DECK
07 42 13.23	METAL COMPOSITE WALL PANELS
07 46 43.A1	COMPOSITION SIDING
08 41 13	ALUMINUM-FRAMED ENTRANCES AND STOREFRONTS
08 44 13	GLAZED ALUMINUM CURTAIN WALL
11 81 23.A1	WINDOW WASHING ANCHOR

#	DATE	CHANGE DESCRIPTION


CML LINDEN BRANCH
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COLUMBUS, OH 43211
FOR
COLUMBUS METROPOLITAN LIBRARY

300 SPRUCE STREET
SUITE 300
COLUMBUS, OHIO 43215
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FAX: (614) 280-8881


EXTERIOR ELEVATIONS - OVERALL

NOVEMBER 21, 2023
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A302
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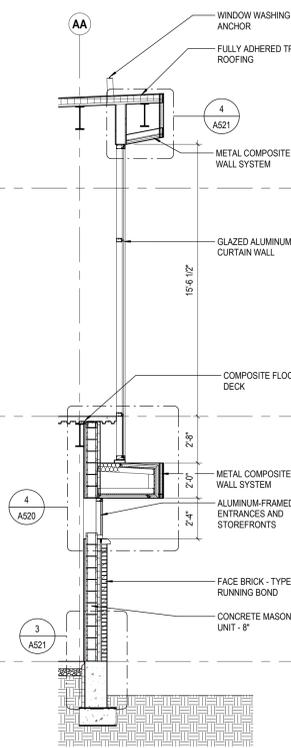
JONATHAN D. MOODY, LIC. #1215709
EXP. DATE: 12/31/2023

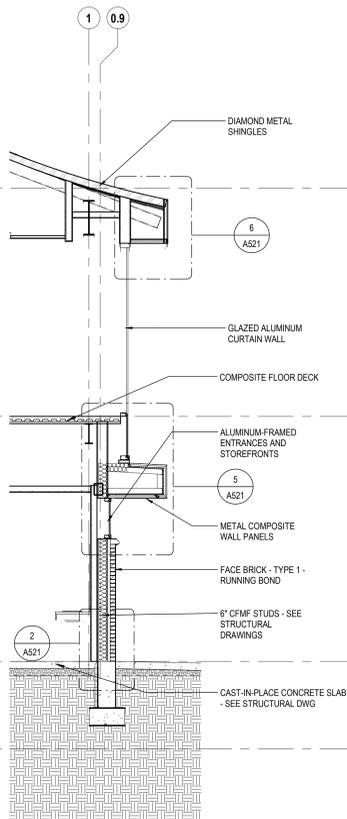


6 SECTION WEST CURTAINWALL @ HOMEWORK HELP
1/4" = 1'-0" REF: 1 / A3.10a

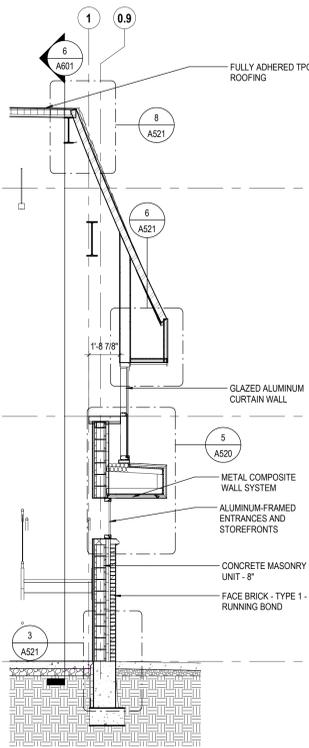


5 SECTION WEST CURTAINWALL @ STAIR SHAFT
1/4" = 1'-0" REF: 1 / A3.10a




4 SECTION SOUTH CURTAINWALL @ STAIR SHAFT
1/4" = 1'-0" REF: 2 / A401

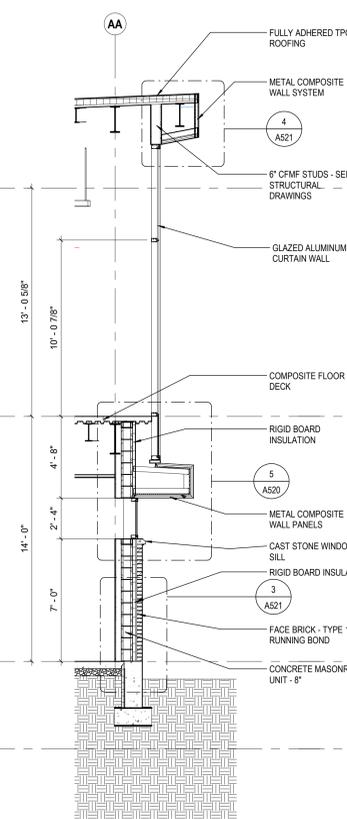


3 SECTION SOUTH CURTAINWALL
1/4" = 1'-0" REF: 2 / A401

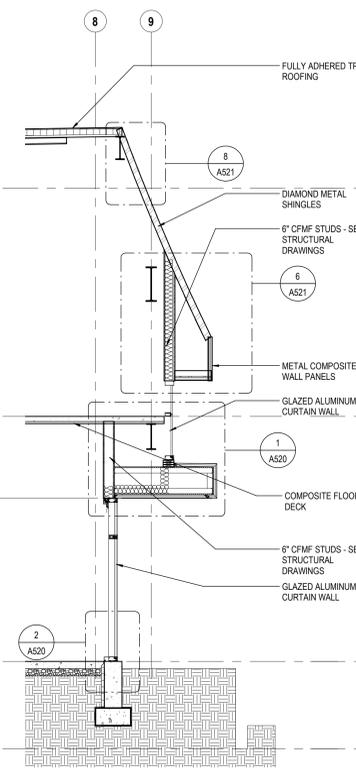


2 SECTION EAST CURTAINWALL
1/4" = 1'-0" REF: 1 / A3.10a

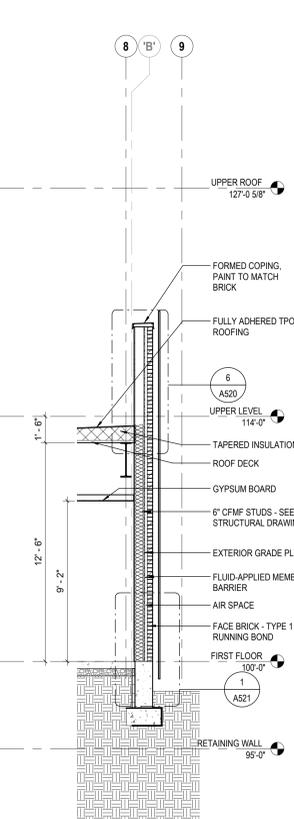


1 SECTION EAST MURAL WALL
1/4" = 1'-0" REF: 1 / A3.10a

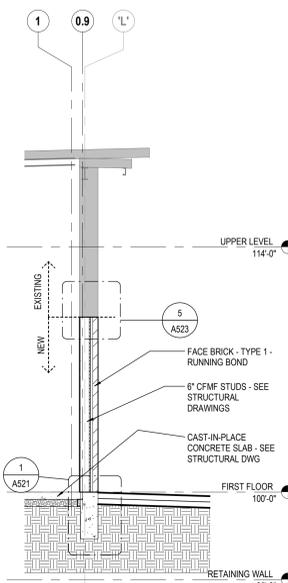


10 SECTION NEW BRICK INFILL
1/4" = 1'-0"

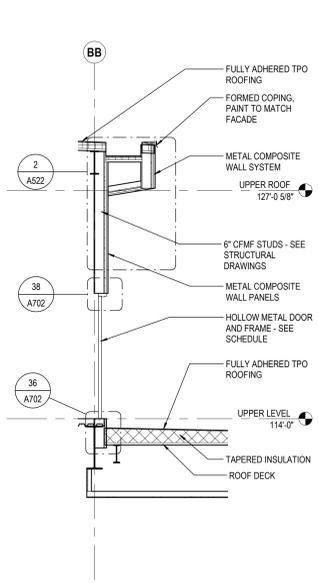

9 SECTION MECHANICAL ROOF ACCESS
1/4" = 1'-0"

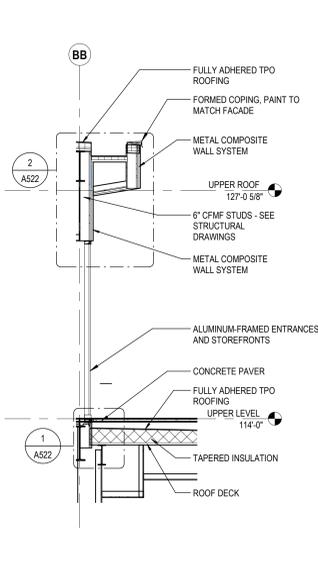

8 SECTION TERRACE CURTAINWALL
1/4" = 1'-0" REF: 4 / A3.11a

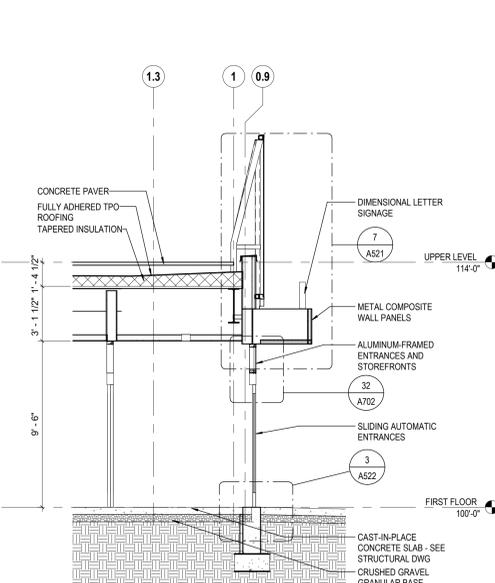

7 SECTION MAIN VESTIBULE W/ TERRACE
1/4" = 1'-0" REF: 1 / A3.10a

GENERAL NOTES - WALL SECTIONS		KEYNOTE LEGEND		#	DATE	CHANGE DESCRIPTION
1.	X	KEY VALUE	KEYNOTE TEXT			
		03 30 00 D1	CAST-IN-PLACE CONCRETE SLAB - SEE STRUCTURAL DWG			
		04 00 00 B1A	FACE BRICK - TYPE 1 - RUNNING BOND			
		04 00 00 D4	CONCRETE MASONRY UNIT - 8"			
		04 00 00 Z1	AIR SPACE			
		04 72 00 A4	CAST STONE WINDOW SILL			
		05 31 00 A1	ROOF DECK			
		05 31 00 B2	COMPOSITE FLOOR DECK			
		05 40 00 A8	6" CFMF STUDS - SEE STRUCTURAL DRAWINGS			
		05 10 00 B1	EXTERIOR GRADE PLYWOOD			
		07 21 00 A1	RIGID BOARD INSULATION			
		07 21 00 P1	SPANDREL GLASS CURTAINWALL INSULATION			
		07 27 26	FLUID-APPLIED MEMBRANE AIR BARRIER			
		07 31 16 A1	DIAMOND METAL SHINGLES			
		07 42 13 Z3	METAL COMPOSITE WALL PANELS			
		07 42 44	METAL COMPOSITE WALL SYSTEM			
		07 54 23 A2	FULLY ADHERED TPO ROOFING			
		07 54 23 B4	TAPERED INSULATION			
		07 62 00 E3	FORMED COPING, PAINT TO MATCH BRICK			
		07 62 00 E4	FORMED COPING, PAINT TO MATCH FACADE			
		07 76 16 A1	CONCRETE PAVER			
		08 11 13 A1	HOLLOW METAL DOOR AND FRAME - SEE SCHEDULE			
		08 41 13	ALUMINUM-FRAMED ENTRANCES AND STOREFRONTS			
		08 42 29	SLIDING AUTOMATIC ENTRANCES			
		08 44 13	GLAZED ALUMINUM CURTAIN WALL			
		09 21 16 M1	GYPSUM BOARD			
		10 14 19	DIMENSIONAL LETTER SIGNAGE			
		11 81 23 A1	WINDOW WASHING ANCHOR			
		31 30 00 C2	CRUSHED GRAVEL GRANULAR BASE			
CODED NOTES - WALL SECTIONS						
1.	X					


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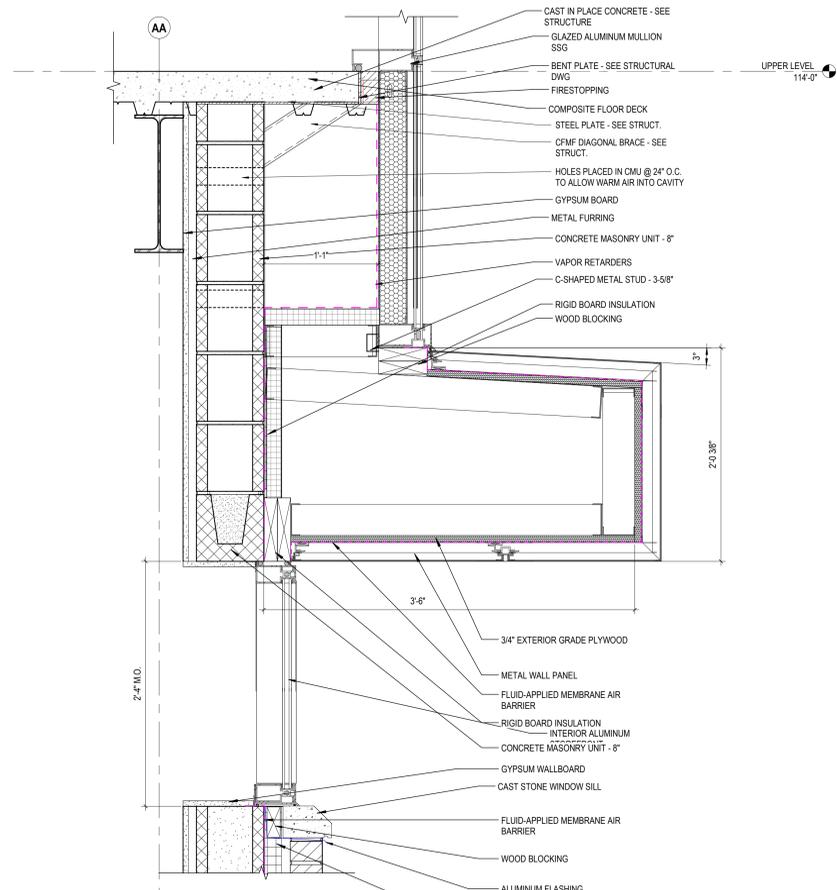
MOODY-NOLAN
DRAWING TITLE:
WALL SECTIONS

NOVEMBER 21, 2023
DRAWN BY: KG CHECKED BY: BL
Proj. # 21507.02
A501
PERMIT SET


JONATHAN D. MOODY, LIC. #1215709
EXP. DATE: 12/31/2023




6 DETAIL BRICK PARAPET @ ROOF
 1 1/2" = 1'-0" REF: 1 / A501

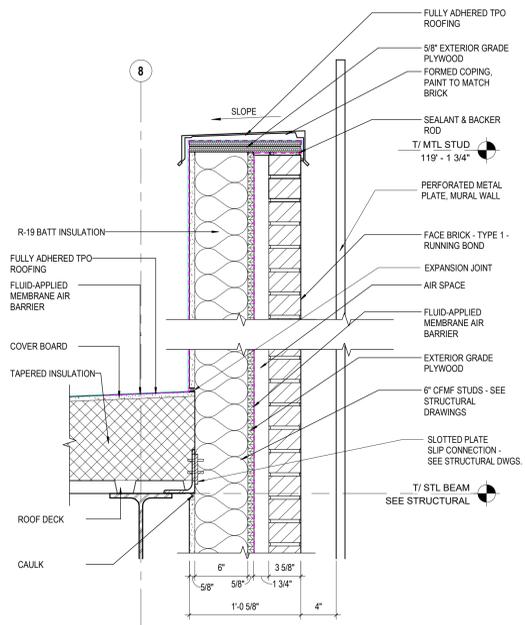


4 DETAIL STOREFRONT @ CANOPY (CMU)
 1 1/2" = 1'-0" REF: 4 / A501

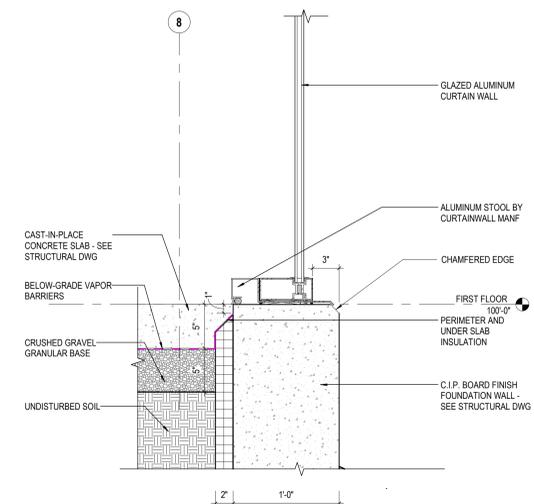


2 DETAIL CURTAINWALL SILL @ S.O.G.
 1 1/2" = 1'-0" REF: 2 / A501

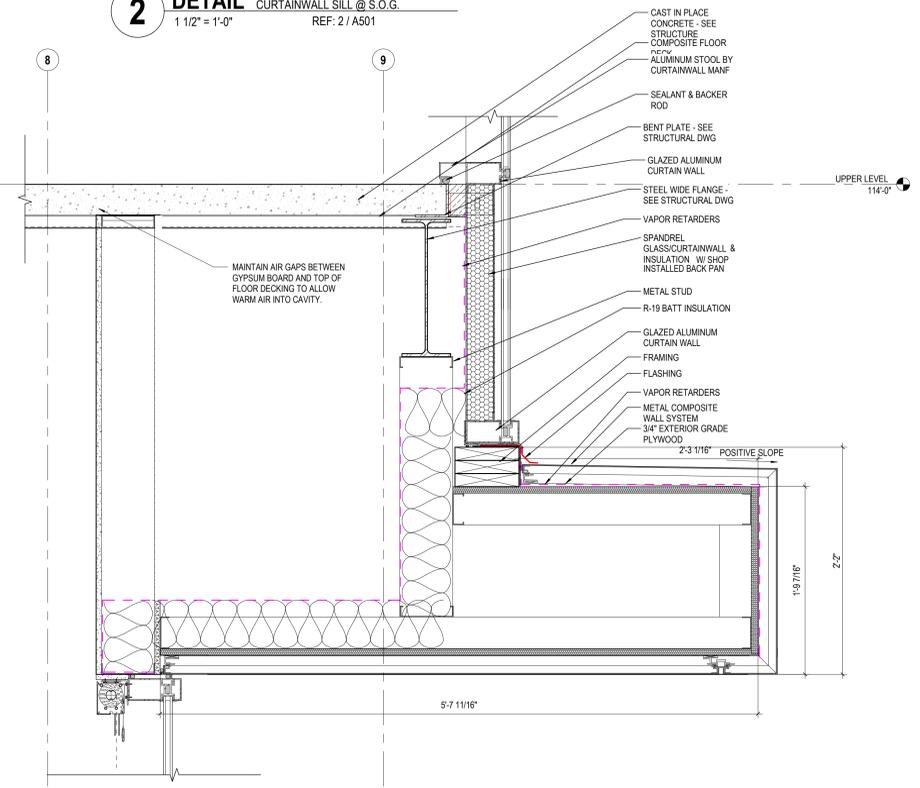

1 DETAIL CURTAINWALL SILL (TYP)
 1 1/2" = 1'-0" REF: 2 / A501

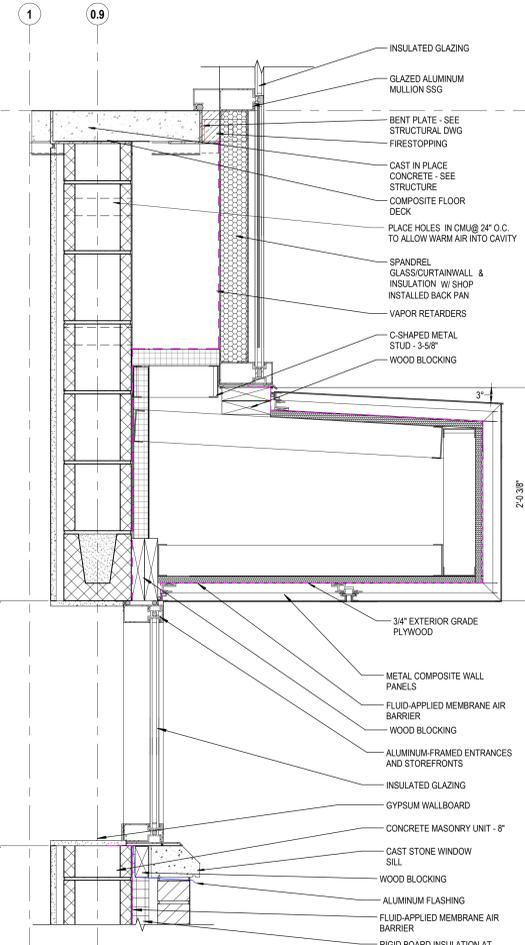

5 DETAIL CURTAINWALL SILL @ CMU
 1 1/2" = 1'-0" REF: 3 / A501

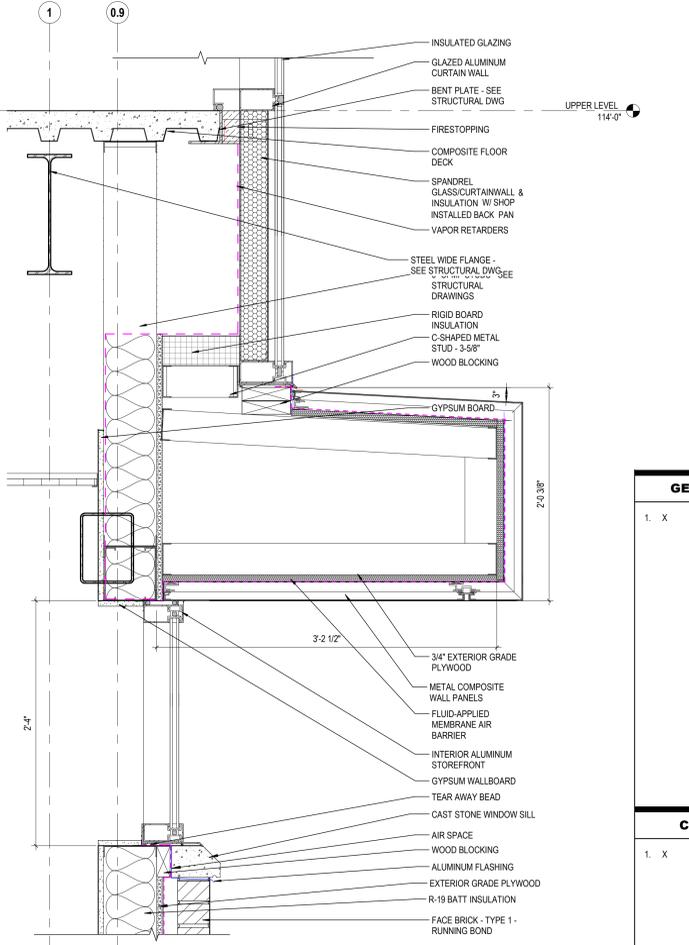

3 DETAIL STOREFRONT @ OVERHANG
 1 1/2" = 1'-0"


GENERAL NOTES - EXTERIOR DETAILS		KEYNOTE LEGEND		#	DATE	CHANGE DESCRIPTION
1. X	03 30 00 A1 03 30 00 D1 03 30 00 D4 04 00 00 B1A 04 00 00 D4 04 00 00 Z1 04 72 00 A4 05 12 00 B1 05 12 00 B5 05 31 00 A1 05 31 00 B2 05 40 00 A 05 40 00 A4 05 40 00 A8 06 10 00 A 06 10 00 A1 06 10 00 B1 06 10 00 B1 06 10 00 B2 07 21 00 A1 07 21 00 B2 07 21 00 D1 07 21 00 H1 07 21 00 P1 07 26 00 07 26 16 07 27 26 07 42 13 07 42 13.23 07 42 44 07 54 23 A2 07 54 23 B3 07 54 23 B4 07 62 00 E3 07 62 00 G1 07 84 00 07 92 00 H3 07 92 00 J1	KEYNOTE TEXT CAST IN PLACE CONCRETE - SEE STRUCTURE CAST-IN-PLACE CONCRETE SLAB - SEE STRUCTURAL DWG C.I.P. BOARD FINISH FOUNDATION WALL - SEE STRUCTURAL DWG FACE BRICK - TYPE 1 - RUNNING BOND CONCRETE MASONRY UNIT - 8" AIR SPACE CAST STONE WINDOW SILL BENT PLATE - SEE STRUCTURAL DWG BENT PLATE - SEE STRUCTURAL DWG ROOF DECK COMPOSITE FLOOR DECK METAL STUD C-SHAPED METAL STUD - 3-5/8" 6" CFMF STUDS - SEE STRUCTURAL DRAWINGS FRAMING WOOD BLOCKING EXTERIOR GRADE PLYWOOD 3/4" EXTERIOR GRADE PLYWOOD 5/8" EXTERIOR GRADE PLYWOOD METAL COMPOSITE WALL PANELS TAPERED INSULATION FORMED COPING, PAINT TO MATCH BRICK COVER BOARD FLUID-APPLIED MEMBRANE AIR BARRIER FLASHING FIRESTOPPING SEALANT & BACKER ROD CAULK	KEYNOTE TEXT ALUMINUM-FRAMED ENTRANCES AND STOREFRONTS INTERIOR ALUMINUM STOREFRONT GLAZED ALUMINUM CURTAIN WALL GLAZED ALUMINUM MULLION SSG ALUMINUM FLASHING ALUMINUM STOOL BY CURTAINWALL MANF INSULATED GLAZING METAL FURRING GYPSUM BOARD TEAR AWAY BEAD GYPSUM WALLBOARD CRUSHED GRAVEL GRANULAR BASE UNDISTURBED SOIL			
CODED NOTES - EXTERIOR DETAILS		1. X				

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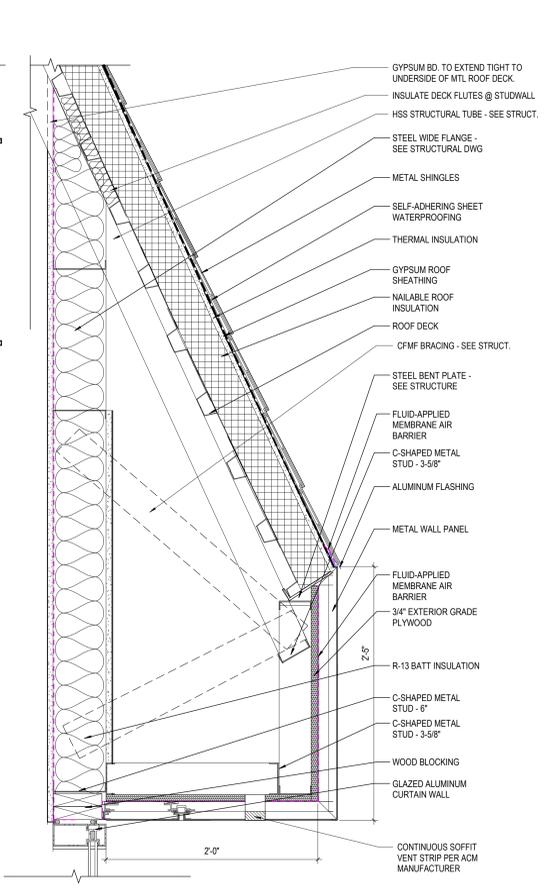
EXTERIOR DETAILS - SECTION

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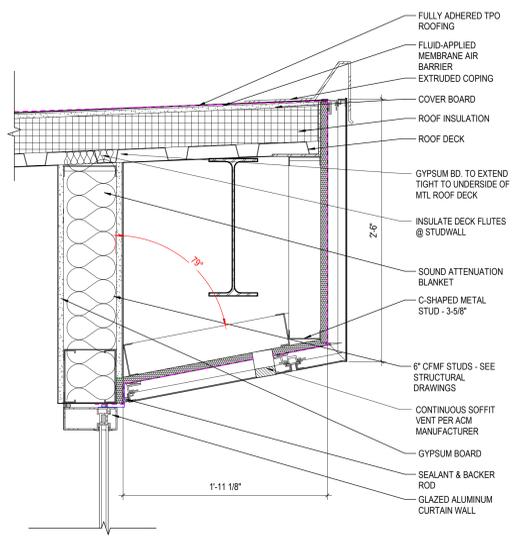
 NOVEMBER 21, 2023
 DRAWN BY: KG CHECKED BY: BL
 Proj. # 21507.02
A520
 PERMIT SET
 JONATHAN D. MOODY, LIC. #1215709
 EXP. DATE: 12/31/2023




8 DETAIL TPO ROOF TRANSITION TO TILE
1 1/2" = 1'-0" REF: 2 / A501

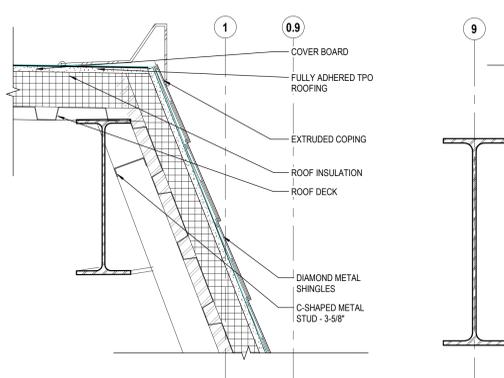


6 DETAIL CURTAINALL HEAD (TYP)
1 1/2" = 1'-0" REF: 2 / A501




4 DETAIL SOUTH CURTAINWALL HEAD
1 1/2" = 1'-0" REF: 3 / A501

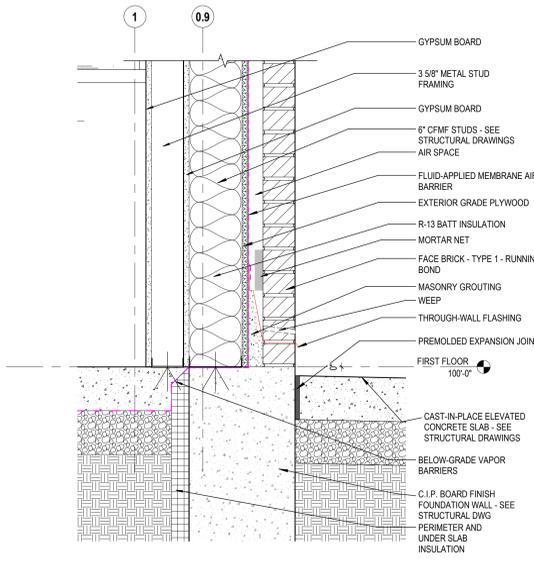


2 DETAIL FOUNDATION (TYP)
1 1/2" = 1'-0" REF: 6 / A501

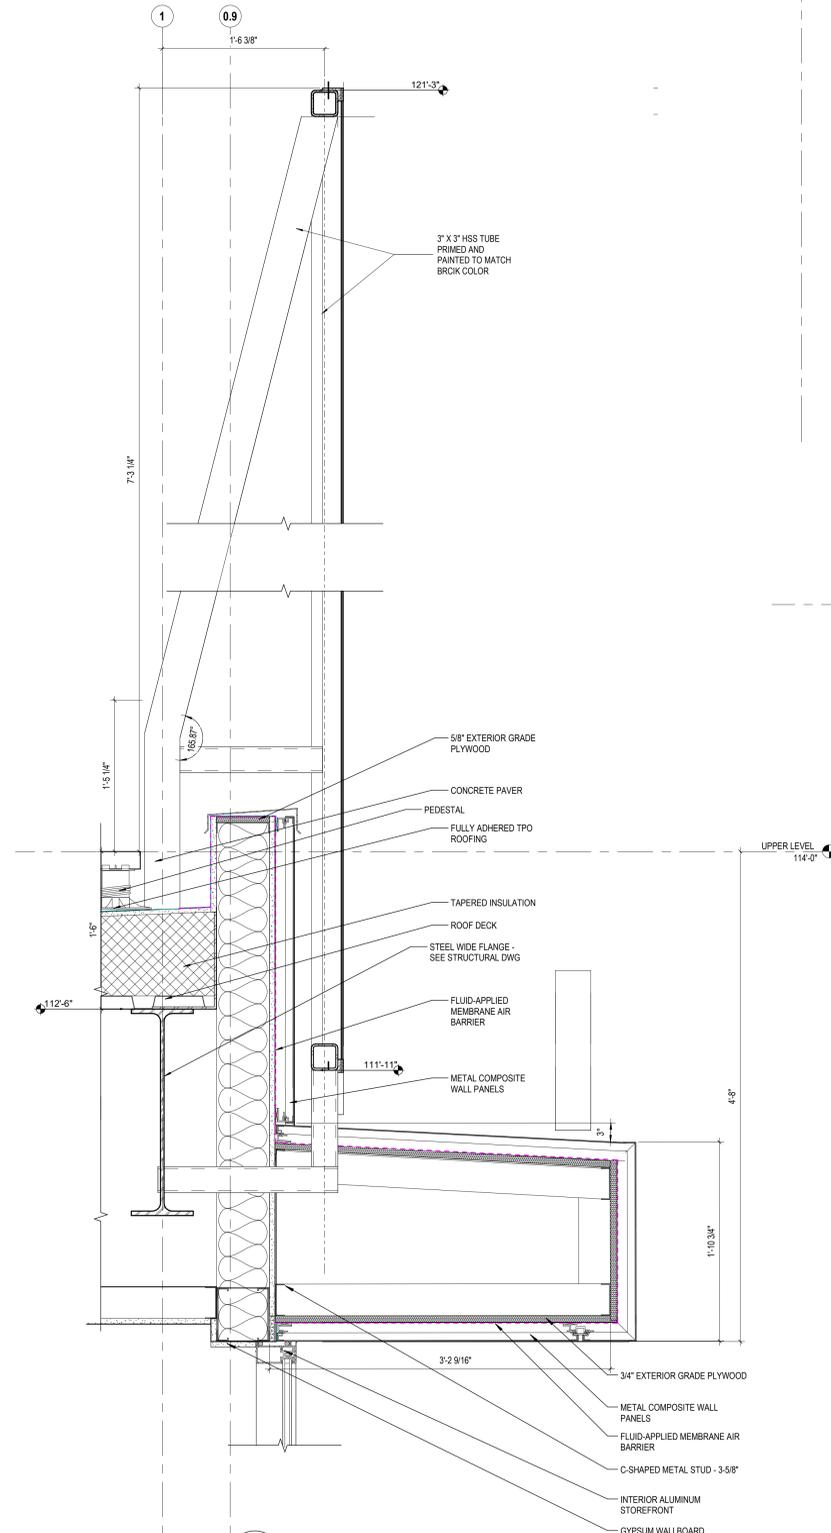


7 DETAIL TERRACE @ WEST MURAL WALL
1 1/2" = 1'-0" REF: 7 / A501

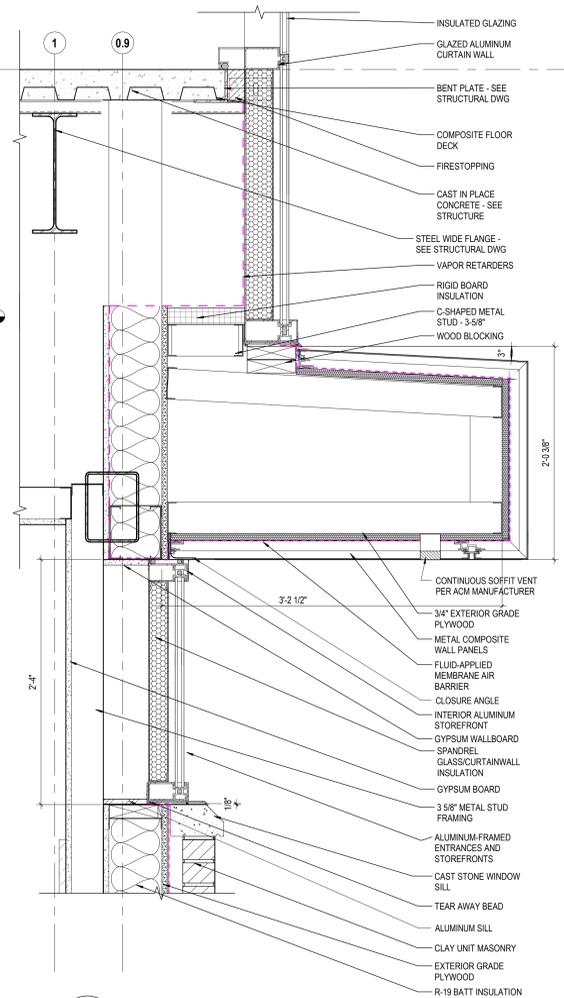

5 DETAIL STOREFRONT SPANDREL @ RESTROOM
1 1/2" = 1'-0" REF: 6 / A501

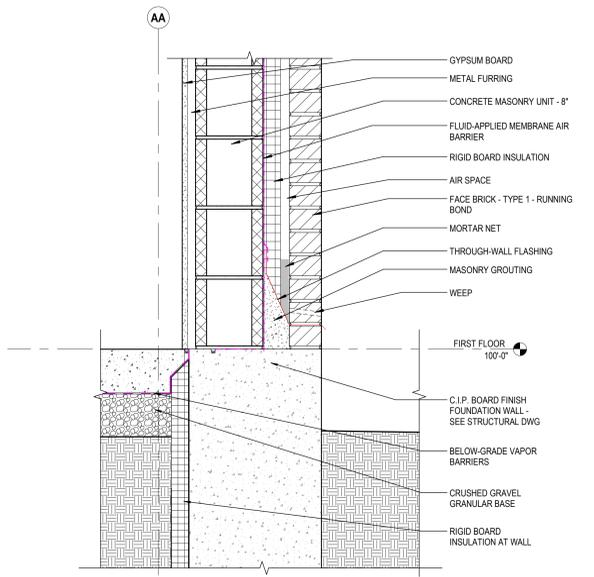

3 DETAIL RETAINING WALL @ STAIR SHAFT
1 1/2" = 1'-0" REF: 3 / A501

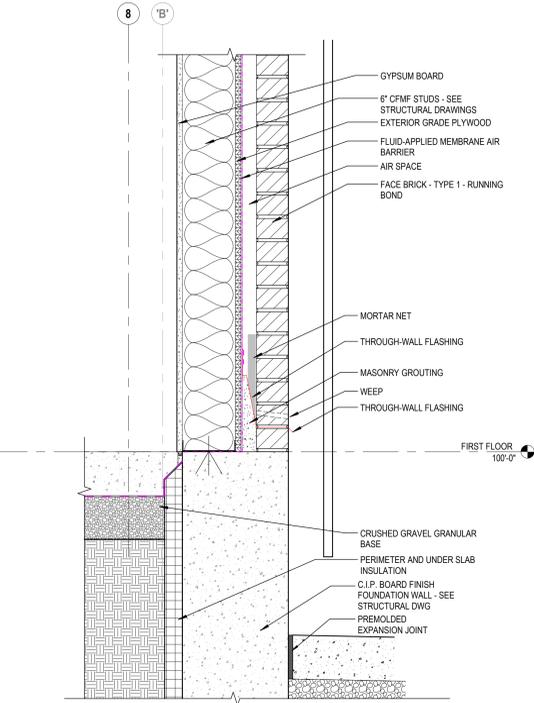

1 DETAIL RETAINING WALL @ SLAB ON GRADE
1 1/2" = 1'-0" REF: 11 / A501

GENERAL NOTES - EXTERIOR DETAILS

1. X	03 30 00.A1	CAST IN PLACE CONCRETE - SEE STRUCTURE
	03 30 00.D4	C.I.P. BOARD FINISH FOUNDATION WALL - SEE STRUCTURAL DWG
	03 30 00.D9	CAST-IN-PLACE ELEVATED CONCRETE SLAB - SEE STRUCTURAL DRAWINGS
	03 30 00.G1	PREMOLDED EXPANSION JOINT
	04 00 00.B1A	FACE BRICK - TYPE 1 - RUNNING BOND
	04 00 00.D4	CONCRETE MASONRY UNIT - 8"
	04 00 00.X15	THROUGH-WALL FLASHING
	04 00 00.X16	WEEP
	04 00 00.Z1	MORTAR NET
	04 05 16	AIR SPACE
	04 21 00	MASONRY GROUTING
	04 72 00.A4	CLAY UNIT MASONRY
	05 12 00.B1	CAST STONE WINDOW SILL
	05 12 00.B5	STEEL WIDE FLANGE - SEE STRUCTURAL DWG
	05 12 00.B7	BENT PLATE - SEE STRUCTURAL DWG
	05 31 00.A1	STEEL BENT PLATE - SEE STRUCTURE
	05 31 00.B2	ROOF DECK
	05 40 00.A4	COMPOSITE FLOOR DECK
	05 40 00.A5	C-SHAPED METAL STUD - 3-5/8"
	05 40 00.A8	C-SHAPED METAL STUD - 6"
	05 40 00.A1	6\"/>
	06 10 00.B1	WOOD BLOCKING
	06 10 50.B1	3/4\"/>
	07 15 26	5/8\"/>
	07 21 00	SELF-ADHERING SHEET WATERPROOFING
	07 21 00.A1	THERMAL INSULATION
	07 21 00.B1	RIGID BOARD INSULATION
	07 21 00.B2	R-13 BATT INSULATION

CODED NOTES - EXTERIOR DETAILS

1. X	07 21 00.D1	PERIMETER AND UNDER SLAB INSULATION
	07 21 00.H1	RIGID BOARD INSULATION AT WALL
	07 21 00.N1	SOUND ATTENUATION BLANKET
	07 21 00.P1	SPANDREL GLASS CURTAINWALL INSULATION
	07 22 19	NAILABLE ROOF INSULATION
	07 26 00	VAPOR RETARDERS
	07 26 16	BELOW-GRADE VAPOR BARRIERS
	07 27 26	FLUID-APPLIED MEMBRANE AIR BARRIER
	07 31 16	METAL SHINGLES
	07 31 16.A1	DIAMOND METAL SHINGLES
	07 42 13	METAL WALL PANEL
	07 42 13.23	METAL COMPOSITE WALL PANELS
	07 50 00	GYPSUM ROOF SHEATHING
	07 54 23.A2	FULLY ADHERED TPO ROOFING
	07 54 23.B1	ROOF INSULATION
	07 54 23.B3	COVER BOARD
	07 54 23.B4	TAPERED INSULATION
	07 62 00.E1	EXTRUDED COPING
	07 76 16.A1	CONCRETE PAVER
	07 76 16.B1	PEDESTAL
	07 84 00	FIRESTOPPING
	07 92 00.H3	SEALANT & BACKER ROD
	08 41 13	ALUMINUM-FRAMED ENTRANCES AND STOREFRONTS
	08 43 14	INTERIOR ALUMINUM STOREFRONT
	08 44 13	GLAZED ALUMINUM CURTAIN WALL
	08 44 13.C1	ALUMINUM FLASHING
	08 81 00.A1	INSULATED GLAZING
	08 21 13.A1	METAL FURRING
	08 21 16.A4	3/8\"/>
	09 21 16.A1	GYPSUM BOARD
	09 21 16.P7	TEAR AWAY BEAD
	09 29 00	GYPSUM WALLBOARD
	31 30 00.C2	CRUSHED GRAVEL GRANULAR BASE

KEYNOTE LEGEND

KEY VALUE	KEYNOTE TEXT	KEY VALUE	KEYNOTE TEXT
07 21 00.D1	PERIMETER AND UNDER SLAB INSULATION	07 21 00.H1	RIGID BOARD INSULATION AT WALL
07 21 00.N1	SOUND ATTENUATION BLANKET	07 21 00.P1	SPANDREL GLASS CURTAINWALL INSULATION
07 22 19	NAILABLE ROOF INSULATION	07 26 00	VAPOR RETARDERS
07 26 16	BELOW-GRADE VAPOR BARRIERS	07 27 26	FLUID-APPLIED MEMBRANE AIR BARRIER
07 31 16	METAL SHINGLES	07 31 16.A1	DIAMOND METAL SHINGLES
07 42 13	METAL WALL PANEL	07 42 13.23	METAL COMPOSITE WALL PANELS
07 50 00	GYPSUM ROOF SHEATHING	07 54 23.A2	FULLY ADHERED TPO ROOFING
07 54 23.B1	ROOF INSULATION	07 54 23.B3	COVER BOARD
07 54 23.B4	TAPERED INSULATION	07 62 00.E1	EXTRUDED COPING
07 76 16.A1	CONCRETE PAVER	07 76 16.B1	PEDESTAL
07 84 00	FIRESTOPPING	07 92 00.H3	SEALANT & BACKER ROD
08 41 13	ALUMINUM-FRAMED ENTRANCES AND STOREFRONTS	08 43 14	INTERIOR ALUMINUM STOREFRONT
08 44 13	GLAZED ALUMINUM CURTAIN WALL	08 44 13.C1	ALUMINUM FLASHING
08 81 00.A1	INSULATED GLAZING	08 21 13.A1	METAL FURRING
08 21 16.A4	3/8\"/>		
09 21 16.A1	GYPSUM BOARD	09 21 16.P7	TEAR AWAY BEAD
09 29 00	GYPSUM WALLBOARD	31 30 00.C2	CRUSHED GRAVEL GRANULAR BASE

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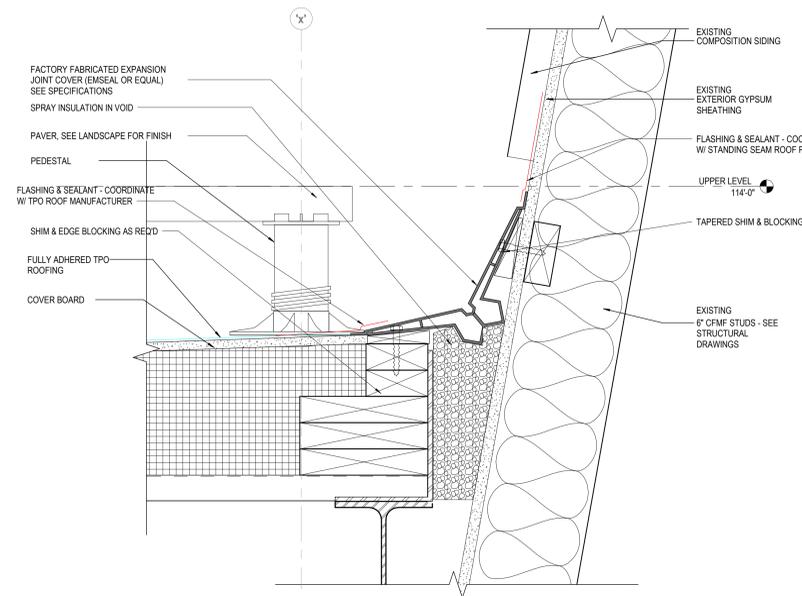
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EXTERIOR DETAILS - SECTION


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Proj. # 21507.02
A521
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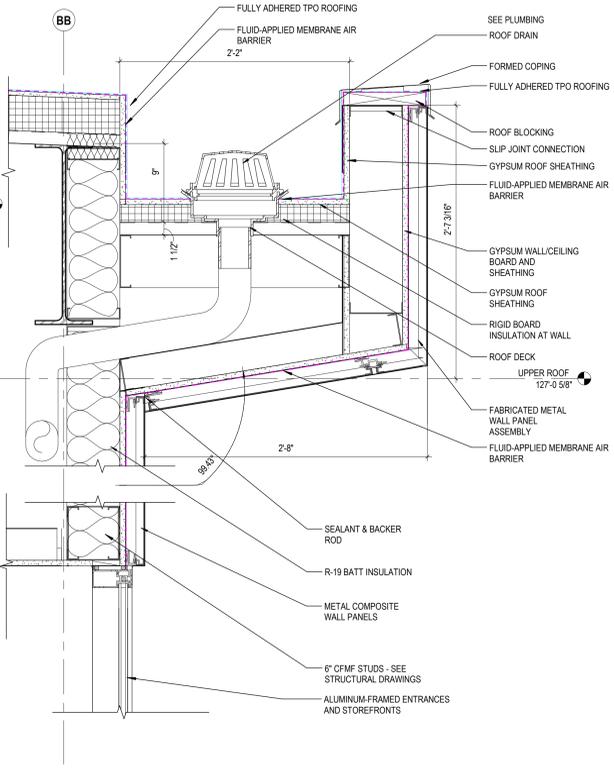
JONATHAN D. MOODY, LIC. #1215709
EXP. DATE: 12/31/2023




6 DETAIL EXPANSION JOINT @ ROOF
3" = 1'-0" REF: 4 / A522




4 DETAIL ROOF @ EXISTING WALL
1 1/2" = 1'-0"

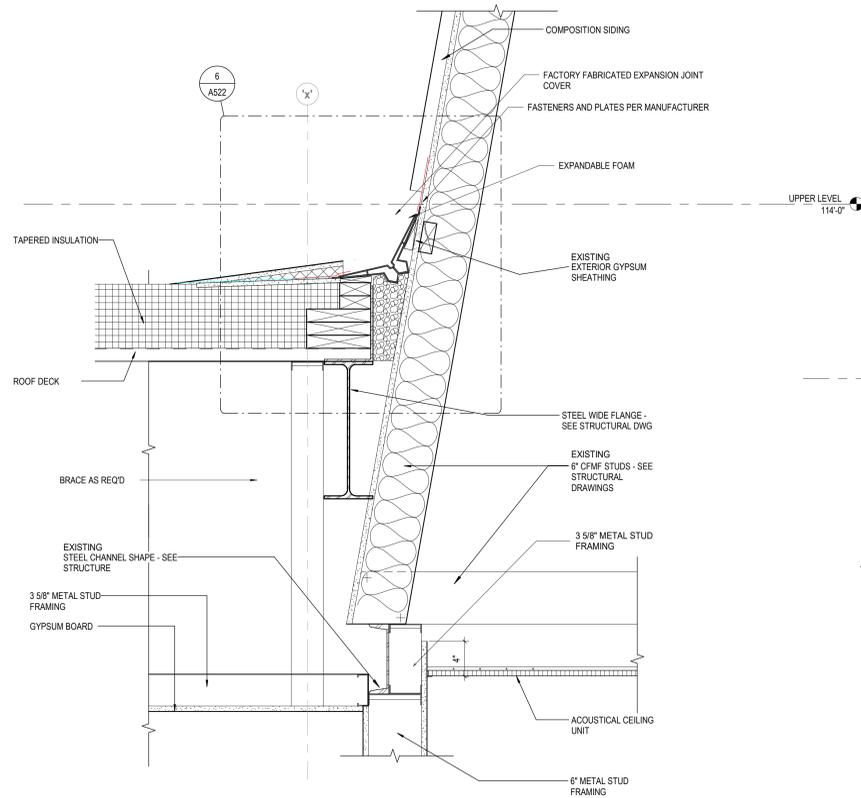


2 DETAIL ROOF DRAINAGE @ TERRACE
1 1/2" = 1'-0" REF: 8 / A501

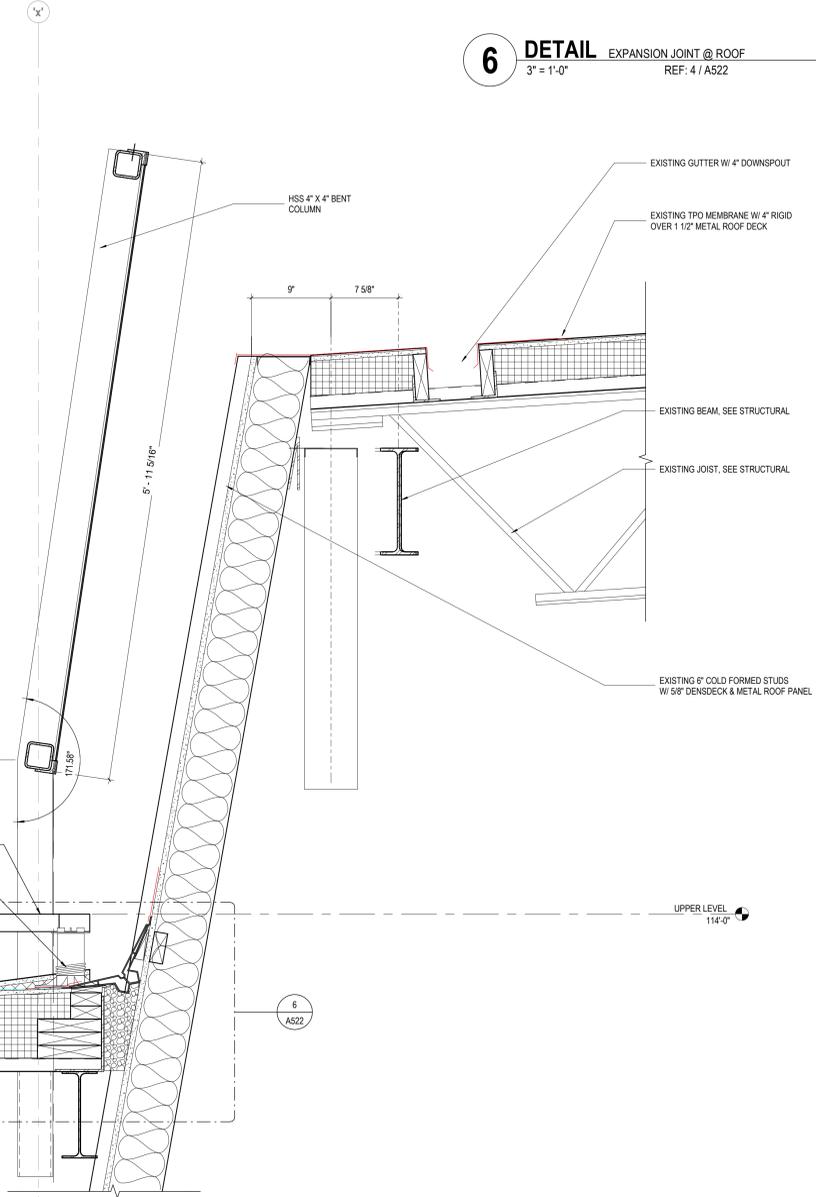

5 DETAIL INTERACTIVE SCREEN WALL
1 1/2" = 1'-0" REF: 3 / A3.11a

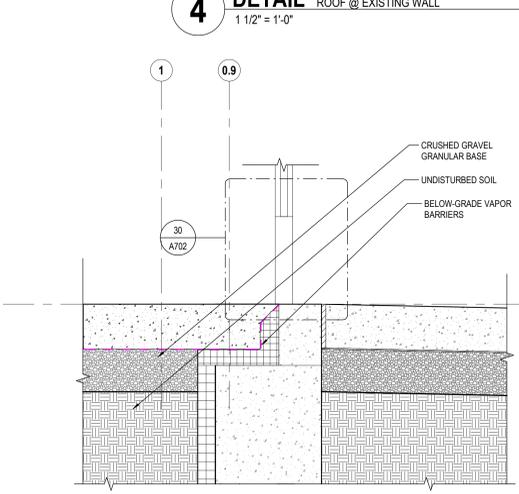

3 DETAIL STOREFRONT SILL ENTRANCE
1 1/2" = 1'-0" REF: 7 / A501

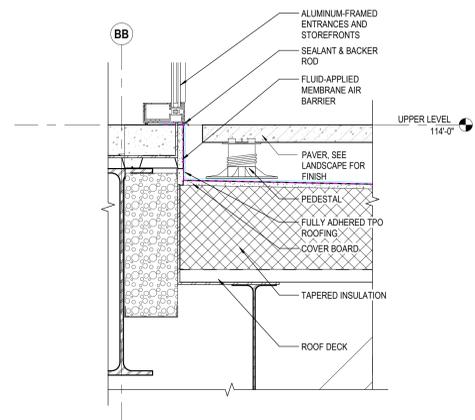

1 DETAIL STOREFRONT SILL @ TERRACE
1 1/2" = 1'-0" REF: 8 / A501

GENERAL NOTES - EXTERIOR DETAILS		KEYNOTE LEGEND		#	DATE	CHANGE DESCRIPTION
KEY VALUE	KEYNOTE TEXT	KEY VALUE	KEYNOTE TEXT			
05 12 00.A2	STEEL CHANNEL SHAPE - SEE STRUCTURE					
05 12 00.B1	STEEL WIDE FLANGE - SEE STRUCTURAL DWG					
05 31 00.A1	ROOF DECK					
05 40 00.A8	6" CFMF STUDS - SEE STRUCTURAL DRAWINGS					
05 40 00.I2	SLIP JOINT CONNECTION					
06 10 50.A1	ROOF BLOCKING					
07 21 00.B2	R-19 BATT INSULATION					
07 21 00.H1	RIGID BOARD INSULATION AT WALL					
07 25 16	BELOW-GRADE VAPOR BARRIERS					
07 27 26	FLUID-APPLIED MEMBRANE AIR BARRIER					
07 42 13.23	METAL COMPOSITE WALL PANELS					
07 42 63	FABRICATED METAL WALL PANEL ASSEMBLY					
07 46 43.A1	COMPOSITION SIDING					
07 50 00	GYPSUM ROOF SHEATHING					
07 54 19.B3	COVER BOARD					
07 54 23.A2	FULLY ADHERED TPO ROOFING					
07 54 23.B4	TAPERED INSULATION					
07 62 00.E2	FORMED COPING					
07 76 16.A1	CONCRETE PAVER					
07 76 16.B1	PEDESTAL					
07 92 00.H3	SEALANT & BACKER ROD					
08 41 13	ALUMINUM-FRAMED ENTRANCES AND STOREFRONTS					
09 21 16.A4	3 5/8" METAL STUD FRAMING					
09 21 16.A6	6" METAL STUD FRAMING					
09 21 16.M1	GYPSUM BOARD					
09 21 16.M5	EXTERIOR GYPSUM SHEATHING					
09 29 00.A	GYPSUM WALL/CEILING BOARD AND SHEATHING					
09 51 13.B	ACOUSTICAL CEILING UNIT					
22 14 26.A1	ROOF DRAIN					
31 30 00.C2	CRUSHED GRAVEL GRANULAR BASE					
31 30 00.F2	UNDISTURBED SOIL					

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NOVEMBER 21, 2023


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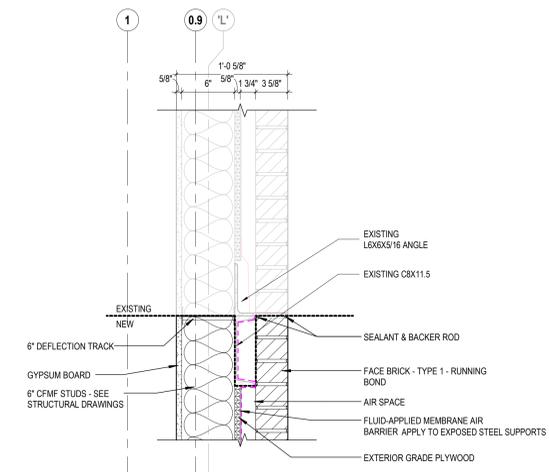
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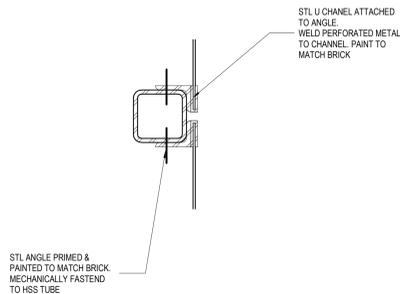
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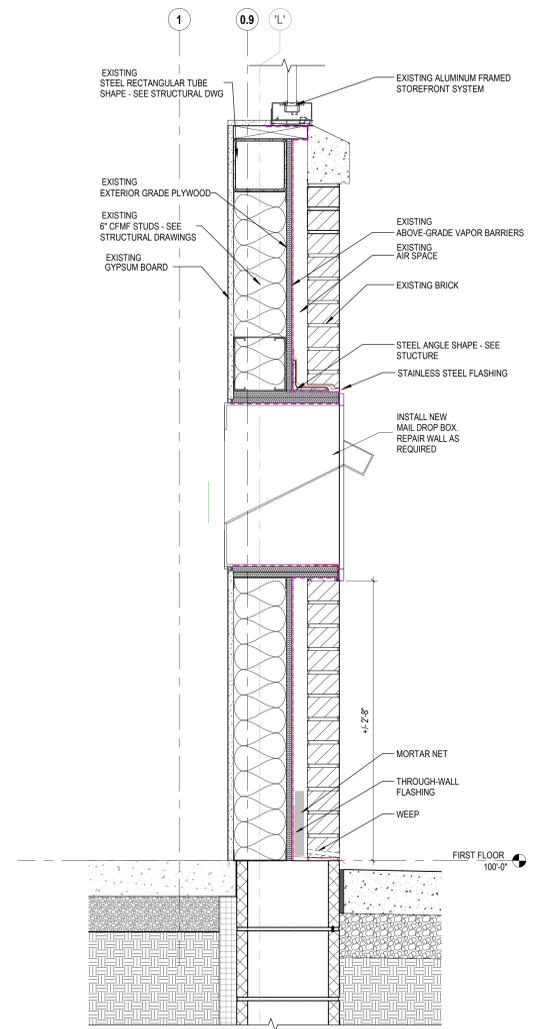
7 DETAIL SCREEN WALL
1 1/2" = 1'-0"




5 DETAIL EXISTING BRICK @ NEW BRICK
1 1/2" = 1'-0" REF: 10 / A501




4 DETAIL VERTICAL SUPPORT OF PERFORATED METAL PANEL
3" = 1'-0"

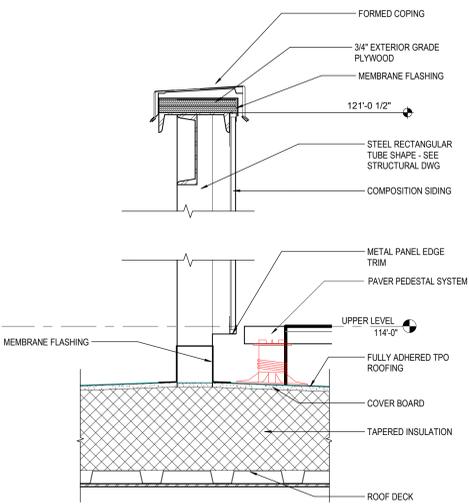


3 DETAIL BOOK DROP
1 1/2" = 1'-0" REF: 1 / A3.10a

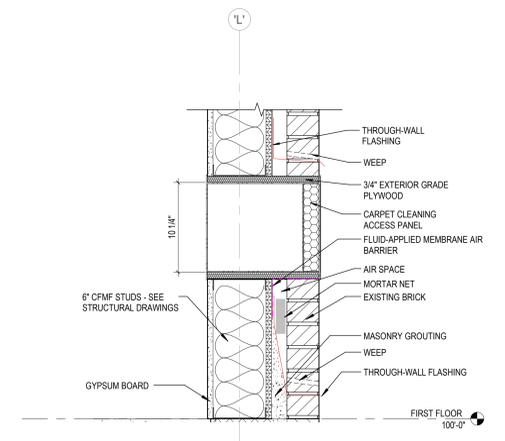


2 DETAIL CARPET CLEANING ACCESS (STUD)
1 1/2" = 1'-0" REF: 1 / A3.10a

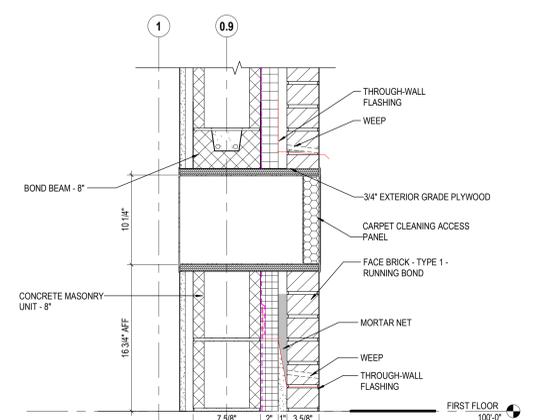

1 DETAIL CARPET CLEANING ACCESS (CMU)
1 1/2" = 1'-0" REF: 1 / A3.10a

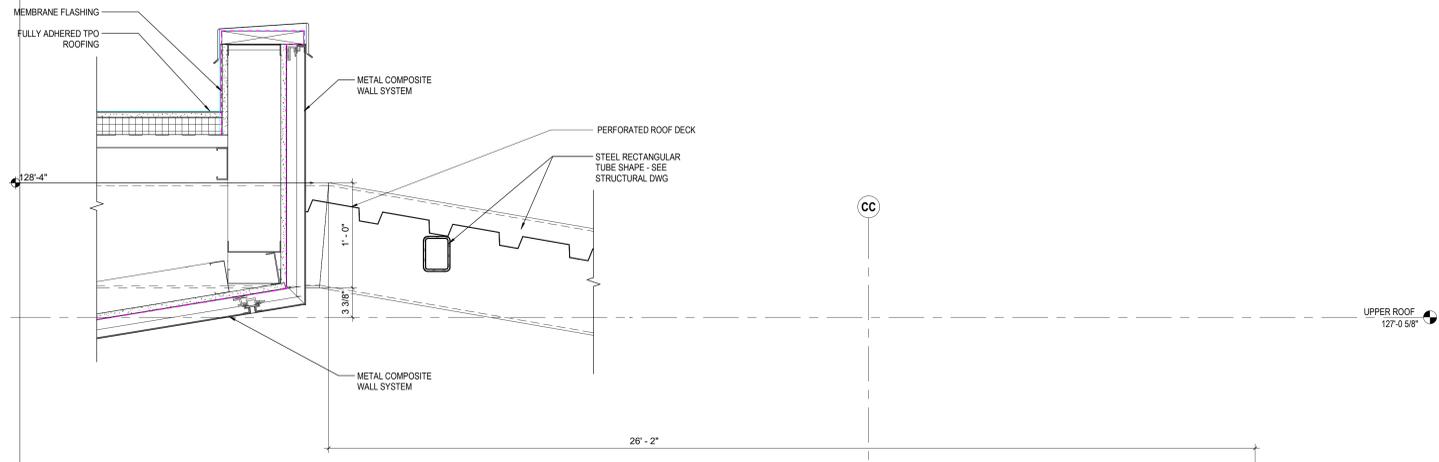

6 DETAIL CANOPY DETAIL
1 1/2" = 1'-0" REF: 3 / A3.11a

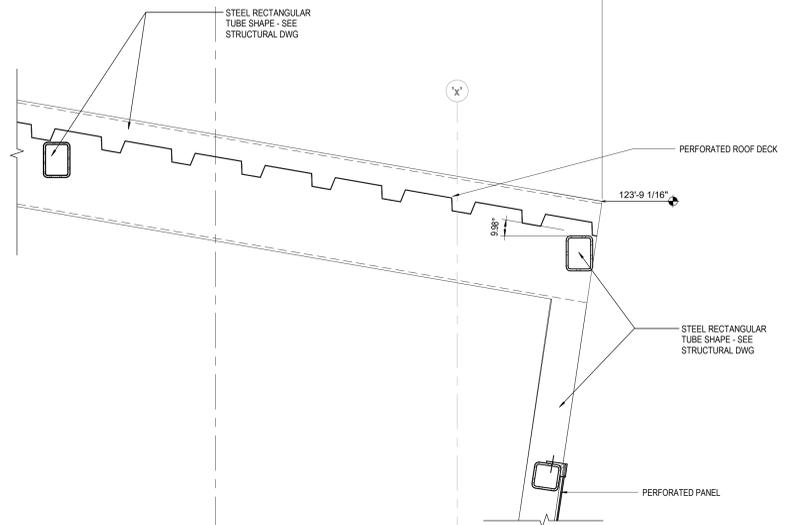

GENERAL NOTES - EXTERIOR DETAILS		KEYNOTE LEGEND		#	DATE	CHANGE DESCRIPTION
1. X	04 00 00 A1 EXISTING BRICK	KEY VALUE	KEYNOTE TEXT			
	04 00 00 B1A FACE BRICK - TYPE 1 - RUNNING BOND					
	04 00 00 D4 CONCRETE MASONRY UNIT - 8"					
	04 00 00 F2 BOND BEAM - 8"					
	04 00 00 K1 THROUGH-WALL FLASHING					
	04 00 00 X4 STAINLESS STEEL FLASHING					
	04 00 00 X15 WEEP					
	04 00 00 X16 MORTAR NET					
	04 00 00 Z1 AIR SPACE					
	04 05 15 MASONRY GROUTING					
	05 12 00 A1 STEEL ANGLE SHAPE - SEE STRUCTURE					
	05 12 00 C1 STEEL RECTANGULAR TUBE SHAPE - SEE STRUCTURAL DWG					
	05 31 00 A1 ROOF DECK					
	05 40 00 A8 6" CFMF STUDS - SEE STRUCTURAL DRAWINGS					
	05 40 00 A11 6" DEFLECTION TRACK					
	06 10 00 B1 EXTERIOR GRADE PLYWOOD					
	06 10 50 B1 3/4" EXTERIOR GRADE PLYWOOD					
	07 26 13 ABOVE-GRADE VAPOR BARRIERS					
	07 27 26 FLUID-APPLIED MEMBRANE AIR BARRIER					
	07 42 13 G7 METAL PANEL EDGE TRIM					
	07 42 44 METAL COMPOSITE WALL SYSTEM					
	07 46 43 A1 COMPOSITION SIDING					
	07 54 23 A2 FULLY ADHERED TPO ROOFING					
	07 54 23 B3 COVER BOARD					
	07 54 23 B4 TAPERED INSULATION					
	07 62 00 E2 FORMED COPING					
	07 62 00 H6 MEMBRANE FLASHING					
	07 62 00 H3 SEALANT & BACKER ROD					
	08 31 13 A1 CARPET CLEANING ACCESS PANEL					
	08 41 13 A1 EXISTING ALUMINUM FRAMED STOREFRONT SYSTEM					
	09 21 16 M1 GYPSUM BOARD					
CODED NOTES - EXTERIOR DETAILS						
1. X						

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